ACHILLES BAY PUBLIC STAIRS ST GEORGE'S PARISH 61-71-201

TITLE SHEET & LOCATION PLAN

GENERAL NOTES


SITE PLAN

GENERAL ARRANGEMENT

PUBLIC ACCESS STAIRS - SHEET 1

PUBLIC ACCESS STAIRS - SHEET 2

S120 BOUNDARY RETAINING WALL

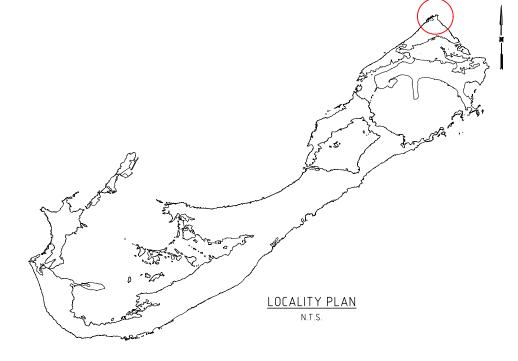



LOCATION PLAN 1:2000

S101

THE MINISTRY OF PUBLIC WORKS

P.O. Box HM525 Hamilton HMCX Bermuda Phone: (441) 295-5151

DEPARTMENT OF WORKS AND ENGINEERING

Fax: (441) 295-5658

1. SURVEY GRID IS BNG2000
2. LEVELS ARE IN METERS
ABOVE ORDINANCE DATUM

AMENDMENTS: NO: | REVISION A FOR INFORMATION 31/10/24 DESIGN
PREPARED: J.M.COLMET DATE: —
CHECKED: — DATE: — DRAWING PREPARED: A.KENNY CHECKED: — DATE: 31/10/2024 DATE: -PROJECT NUMBER: 61-71-201

ISSUED FOR: INFORMATION

ACHILLES BAY ST GEORGE'S PARISH

TITLE SHEET & LOCATION PLAN

ACHILLES BAY PUBLIC STAIRS

REVISION A

<u>NOTES</u>

0.0 GENERAL

- 0.1 HEALTH AND SAFETY IS THE PRIMARY CONSIDERATION AT ALL TIMES. ALL WORKS SHALL BE CONDUCTED IN ACCORDANCE WITH ALL RELEVANT HEALTH AND SAFETY CODES, ACTS AND REGULATIONS.
- 0.2 ALL WORKS, WORKMANSHIP, MATERIALS, QUALITY AND SPECIFICATIONS SHALL SATISFY THE REQUIREMENTS OF THE CURRENT BERMUDA RESIDENTIAL BUILDING CODE FOR CONSTRUCTION. UNLESS NOTED OTHERWISE.

03BRBC ONLINE:

HTTPS://PLANNING.GOV.BM/WP-CONTENT/UPLOADS/2018/11/BERMUDA-RESIDENTIAL-BUILDING-CODE-2014.PDF

- 1.1 FOUNDATIONS ARE TO BEAR ON UNDISTURBED COMPACTED FILL OR BEDROCK. BEARING MATERIAL IS TO REMAIN UNDISTURBED AND BE REVIEWED BY THE ENGINEER PRIOR TO POURING CONCRETE.
- 1.2 ANY SOFT AREAS IN ROCK ARE TO BE REMOVED AND FILLED WITH 2,000 PSI CONCRETE.
- 1.3 STAIR SLAB THROAT TO BE 10" MINIMUM AND 12" THICK ON THE VERTICAL.
- 1.4 12" BLOCK WALL TO BE LAID ON A STEPPED FOOTING, CAST INTEGRAL WITH THE SLAB AND HAVING A LEVEL TOP SURFACE.

2.0 CONCRETE

- 2.1 ALL CONCRETE WORK IS TO BE IN ACCORDANCE WITH THE SPECIFICATIONS.
- 2.2 ALL CONCRETE TO HAVE A MINIMUM STRENGHT OF 3000 PSI @ 28 DAYS
- 2.3 CONCRETE COVER TO REINFORCING STEEL TO BE 3".
- 2.4 REINFORCING CHAIRS TO BE PLASTIC OR CONCRETE.
- 2.5 NO ADDITIVES TO BE USED WITHOUT THE PRIOR APPROVAL OF THE ENGINEER.

3.0 REINFORCING STEEL

- 3.1 REINFORCING STEEL TO HAVE A MINIMUM YIELD STRENGTH OF 410 MPA, TYPE 2 DEFORMED TO BS4449.
- 3.2 REINFORCING STEEL TO BE GALVANISED.
- 3.3 COLD-SPRAY ZINC TO BE APPLIED (PER MANUFACTURERS INSTRUCTIONS) TO ALL FIELD CUTS AND BENDS.

4.0 INSPECTION AND TESTING

4.1 CONTRACTOR TO PROVIDE MINIMUM 24 HOURS NOTICE FOR THE INSPECTION OF ALL REINFORCING PRIOR TO POURING

5.1 GRANULAR BACKFILL MATERIAL SHALL BE COMPACTED TO 95% MPT @ OMC OR EQUIVALENT APPROVED. ALTERNATIVELY, IN THE ABSENCE OF APPROPRIATE FACILITIES REQUIRED TO DETERMINE THE RELEVANT SOIL PROPERTIES AND OR COMPACTION PARAMETERS, THE FOLLOWING 'METHODS-BASED' APPROACH MAY BE USED: ENSURE FILL MATERIAL HAS A WATER CONTENT OF 7% TO 10%, PLACE MATERIAL IN 6" LIFTS AND COMPACT TO 4".

6.0 TEMPORARY SHORING

6.1 ENSURE THAT THE EXCAVATED EMBANKMENT IS ADEQUATELY SHORED OR THAT THE EMBANKMENT IS SUFFICIENTLY SLOPED TO PREVENT COLLAPSE.

7.0 REINFORCEMENT LAP LENGTHS

7.1 MINIMUM ALLOWABLE LAP LENGTHS FOR REINFORCED CONCRETE CONSTRUCTION: WWF, ONE SQUARE 3/8" (T10 MM) DIAMETER BAR, 18" (1'-6") 1/2" (T12 MM) DIAMETER BAR, 24" (2'-0")

5/8" (T16 MM) DIAMETER BAR. 30" (2'-6") 3/4" (T20 MM) DIAMETER BAR, 36" (3'-0")

7.2 MINIMUM ALLOWABLE LAP LENGTHS FOR MASONRY CONSTRUCTION:

WWF, ONE SQUARE 3/8" (T10 MM) DIAMETER BAR, 20" (1'-8") 1/2" (T12 MM) DIAMETER BAR, 24" (2'-0") 5/8" (T16 MM) DIAMETER BAR, 32" (2'-8") 3/4" (T20 MM) DIAMETER BAR, 40" (3'-4")

8.0 INFILL & BACKFILL

8.1 ANY CONCRETE INFILL BETWEEN THE WALL AND THE ROCK-CUT TO BE POURED IN 24" LIFTS MAX.

8.2 FILL MATERIAL BETWEEN THE STAIRWELL WALL AND THE ADJACENT SUBSTRATE SHOULD BE & STONE WITH FILTER CLOTH BETWEEN THE 5/8" STONE AND THE GRANULAR (SANDY SOIL) SUBSTRATE.

10.0 CONCRETE BLOCK

10.1 ALL EXPOSED FACES OF CONCRETE BLOCK TO RECEIVE PLASTER FINISH.

11.0 EXCAVATION FOR STAIRS

11.1 STAIRS TO BEAR ON SOUND BEDROCK. THE STAIRS MAY NEED TO BE SHIFTED INLAND IN ORDER TO ACCOMMODATE THEIR BEARING ON SOUND BEDROCK.

12.1 STAINLESS STEEL PIPE AND PLATE TO BE SUPPLIED BY GOVERNMENT. FABRICATION AND INSTALL ARE THE RESPONSIBILITY OF THE CONTRACTOR.

THE MINISTRY OF PUBLIC WORKS

P.O. Box HM525 Hamilton HMCX Bermuda Phone: (441) 295-5151

DEPARTMENT OF WORKS AND ENGINEERING

Fax: (441) 295-5658

GENERAL NOTES:

1. SURVEY GRID IS BNG2000

2. LEVELS ARE IN METERS

ABOVE ORDINANCE DATUM

AMENDMENTS: NO: | REVISION A FOR INFORMATION 31/10/24 SCALE: AS SHOWN AT ANSI D SURVEY PREPARED: -

ISSUED FOR: INFORMATION

DESIGN
PREPARED: J.M.COLMET DATE: CHECKED: - DATE: -

DRAWING
PREPARED: A.KENNY DATE: 31/10/2024 CHECKED: -

APPROVED BY: A.KENNY

PROJECT NUMBER: 61-71-201

ACHILLES BAY

PUBLIC STAIRS

ACHILLES BAY ST GEORGE'S PARISH

GENERAL NOTES

SHEET NUMBER: S102

REVISION A



1:250

TOURISM COASTAL RESERVE PARK WATER RESOURCE PROTECTION AREA

15000

THE MINISTRY OF

PUBLIC WORKS
P.O. Box HM525
Hamilton HMCX Bermuda
Phone: (441) 295-5151

DEPARTMENT OF WORKS AND ENGINEERING

Fax: (441) 295-5658

GENERAL NOTES:

1. SURVEY GRID IS BNG2000

2. LEVELS ARE IN METERS
ABOVE ORDINANCE DATUM

3. 9 COOT POND ROAD:
37443 SQFT

AMENDMENTS: NO: REVISION A FOR INFORMATION 31/10/24 SCALE: AS SHOWN AT ANSI D

SURVEY PREPARED: –

ISSUED FOR: INFORMATION

DESIGN
PREPARED: J.M.COLMET DATE: —
CHECKED: — DATE: —

DRAWING
PREPARED: A.KENNY DATE: 31/10/2024
CHECKED: — DATE: —

APPROVED BY: A.KENNY

PROJECT NUMBER: 61-71-201 PROJECT NAME:


ACHILLES BAY PUBLIC STAIRS

ACHILLES BAY ST GEORGE'S PARISH SHEET TITLE:

HOUSING ARRANGEMENT

SHEET NUMBER: REVISION S001 Α



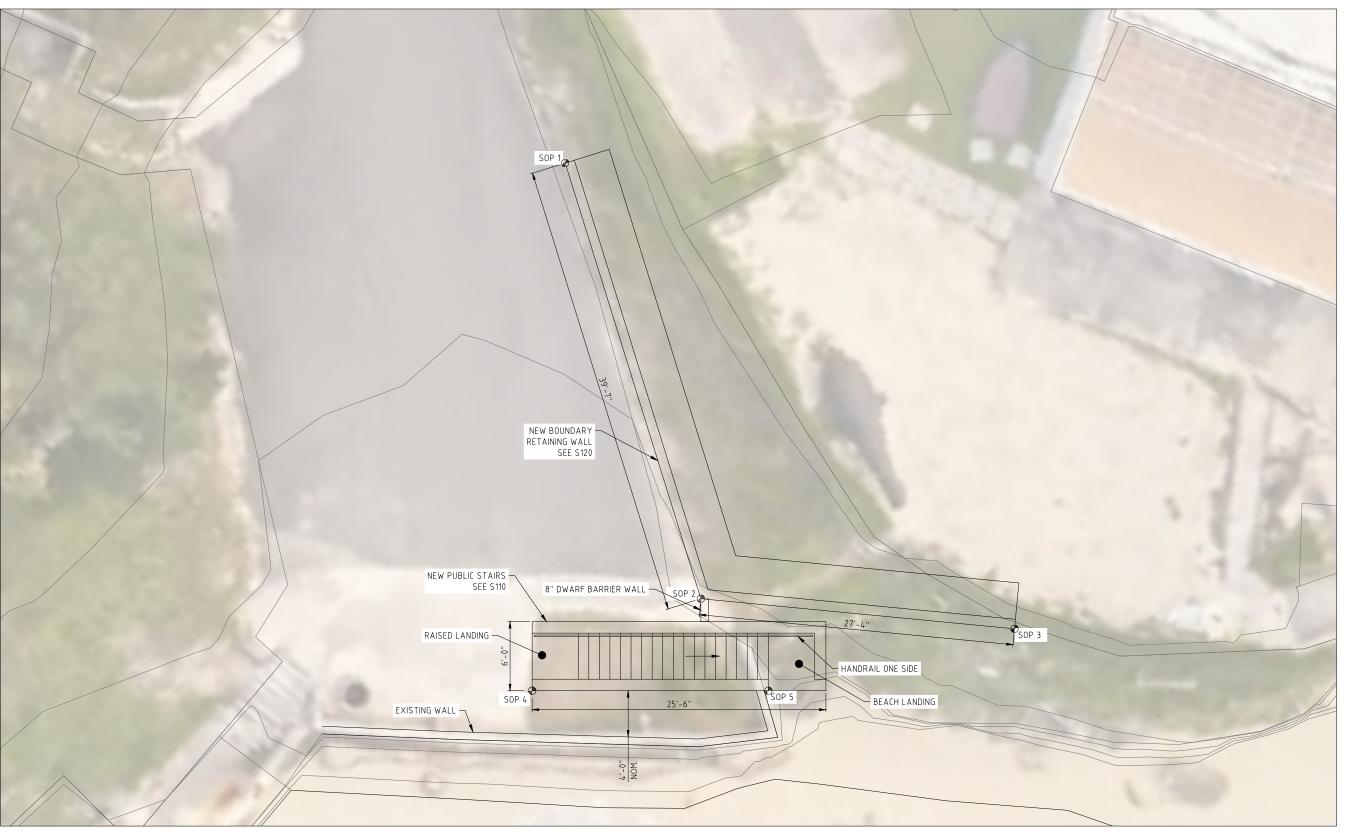

SET OUT POINTS		
ID	EASTING	NORTHING
SOP 1		
SOP 2		
SOP 3		
SOP 4		
SOP 5		

SET-OUT POINTS TBD BY GOVERNMENT SURVEYOR

GENERAL ARRANGEMENT 1:50

> 2000 3000 SCALE 1:50 AT ORIGINAL SIZE

THE MINISTRY OF

PUBLIC WORKS
P.O. Box HM525
Hamilton HMCX Bermuda
Phone: (441) 295-5151

DEPARTMENT OF WORKS AND ENGINEERING

Fax: (441) 295-5658

GENERAL NOTES:

1. SURVEY GRID IS BNG2000

2. LEVELS ARE IN METERS
ABOVE ORDINANCE DATUM

AMENDMENTS: NO: REVISION A FOR INFORMATION 31/10/24 SCALE: AS SHOWN AT ANSI D SURVEY PREPARED: – DESIGN
PREPARED: J.M.COLMET DATE: —
CHECKED: — DATE: — DRAWING
PREPARED: A.KENNY DATE: 31/10/2024
CHECKED: — DATE: — APPROVED BY: A.KENNY PROJECT NUMBER: 61-71-201 PROJECT NAME:


ISSUED FOR: INFORMATION


ACHILLES BAY ST GEORGE'S PARISH SHEET TITLE:

GENERAL ARRANGEMENT

ACHILLES BAY PUBLIC STAIRS

SHEET NUMBER: REVISION S104 A

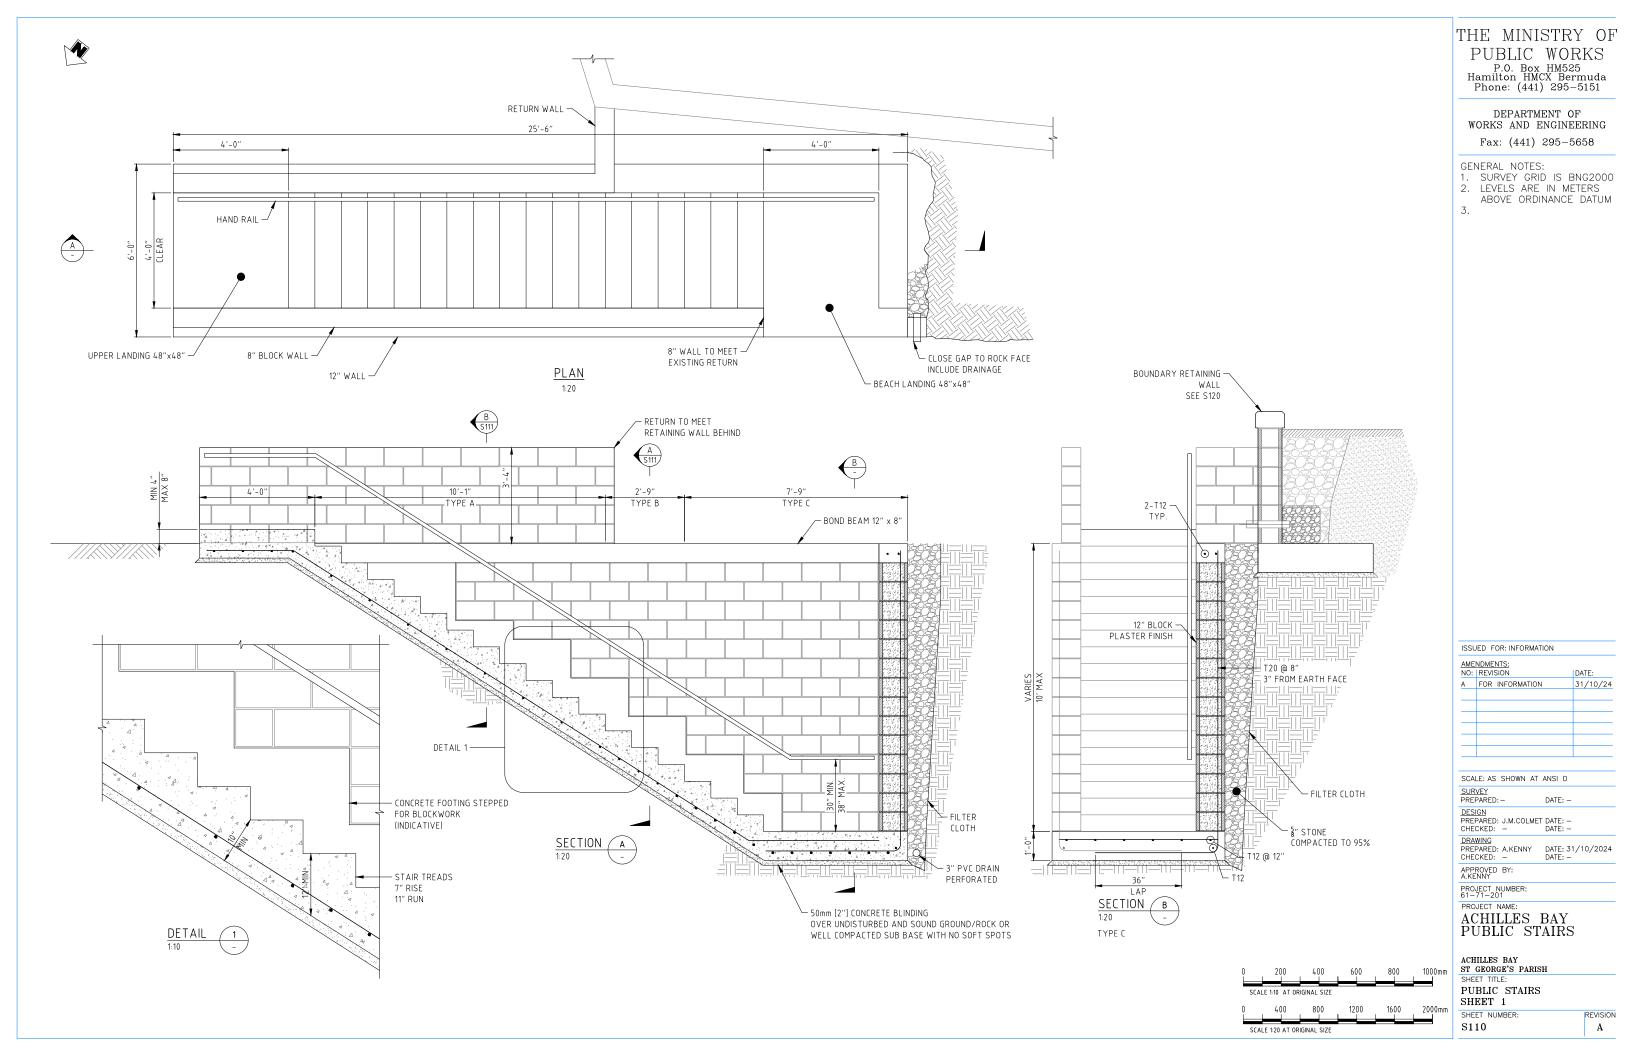

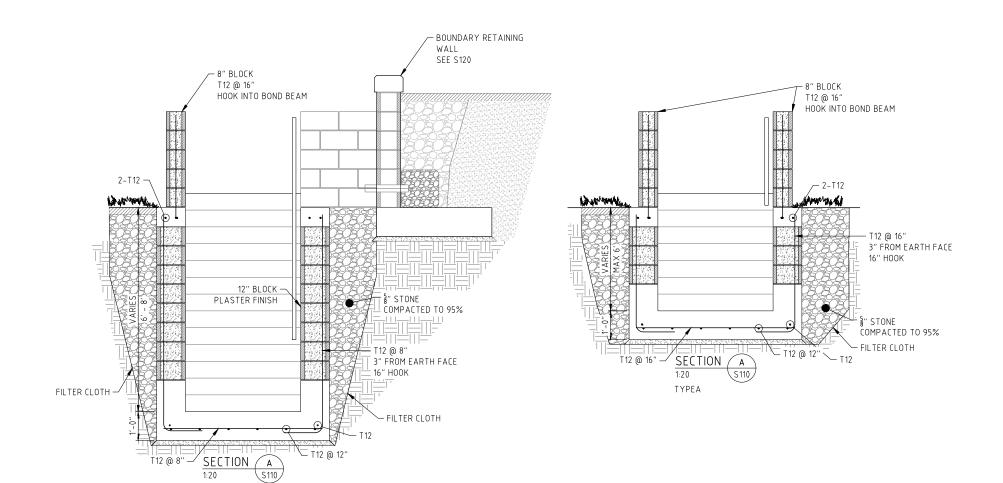

TYPE B

THE MINISTRY OF PUBLIC WORKS

P.O. Box HM525 Hamilton HMCX Bermuda Phone: (441) 295-5151

DEPARTMENT OF WORKS AND ENGINEERING Fax: (441) 295-5658

GENERAL NOTES:

1. SURVEY GRID IS BNG2000
2. LEVELS ARE IN METERS
ABOVE ORDINANCE DATUM

AMENDMENTS: NO: REVISION A FOR INFORMATION 31/10/24 SCALE: AS SHOWN AT ANSI D SURVEY PREPARED: -DESIGN
PREPARED: J.M.COLMET DATE: —
CHECKED: — DATE: — DRAWING
PREPARED: A.KENNY DATE: 31/10/2024
CHECKED: — DATE: — APPROVED BY: A.KENNY PROJECT NUMBER: 61-71-201 PROJECT NAME: ACHILLES BAY PUBLIC STAIRS


ACHILLES BAY
ST GEORGE'S PARISH
SHEET TITLE: PUBLIC STAIRS SHEET 2 SHEET NUMBER:


S111

REVISION

A

ISSUED FOR: INFORMATION

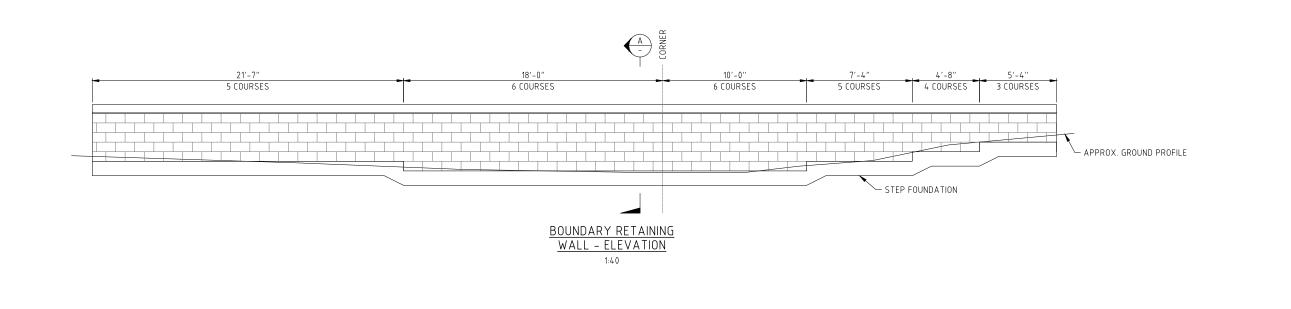

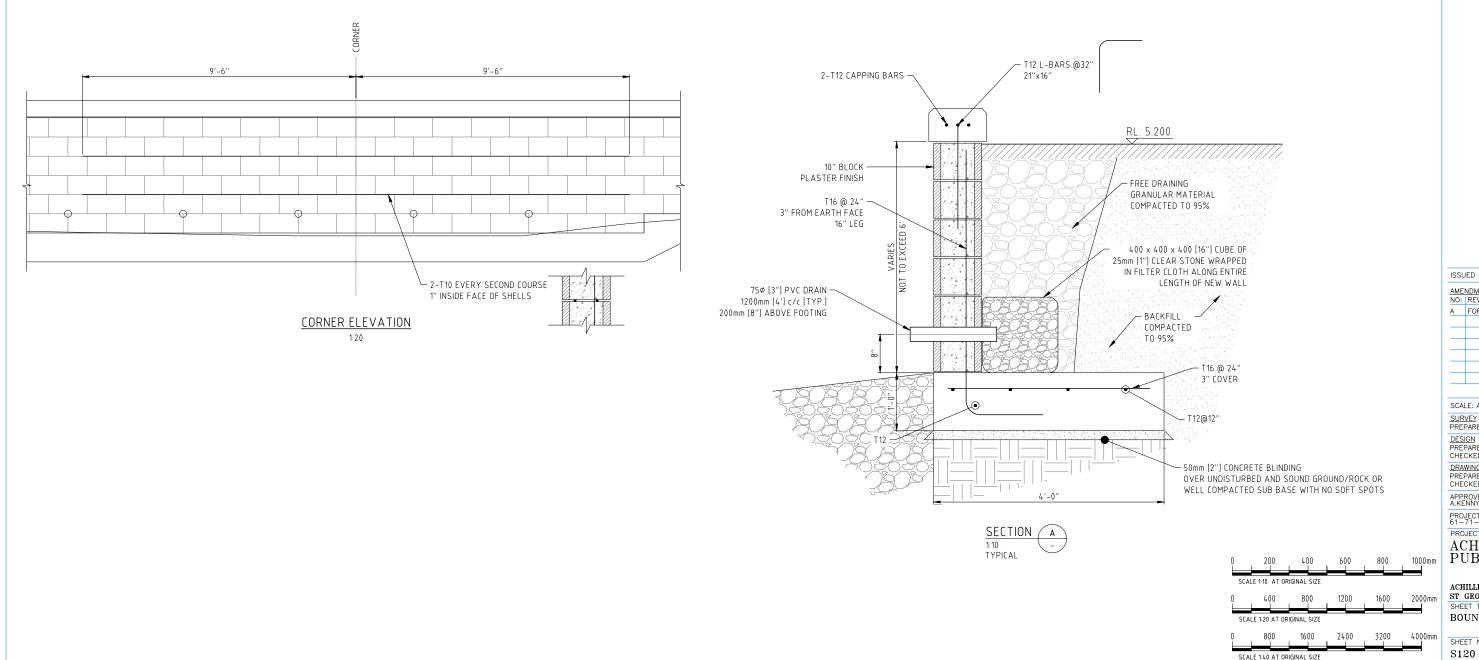

THE MINISTRY OF PUBLIC WORKS

P.O. Box HM525 Hamilton HMCX Bermuda Phone: (441) 295-5151

DEPARTMENT OF WORKS AND ENGINEERING

Fax: (441) 295-5658

GENERAL NOTES:

1. SURVEY GRID IS BNG2000
2. LEVELS ARE IN METERS
ABOVE ORDINANCE DATUM

ISSUED FOR: INFORMATION AMENDMENTS: NO: | REVISION A FOR INFORMATION 31/10/24 SCALE: AS SHOWN AT ANSI D SURVEY PREPARED: -DESIGN
PREPARED: J.M.COLMET DATE: —
CHECKED: — DATE: — DRAWING
PREPARED: A.KENNY DATE: 31/10/2024
CHECKED: DATE: -APPROVED BY: A.KENNY PROJECT NUMBER: 61-71-201 PROJECT NAME: ACHILLES BAY PUBLIC STAIRS ACHILLES BAY ST GEORGE'S PARISH

BOUNDARY RETAINING WALL

REVISION

A

SHEET NUMBER:

SCALE 1:40 AT ORIGINAL SIZE