# REPAIR EXTERIOR CLADDING OF EXISTING TYNES BAY SWRO PLANT AT 56 NORTH SHORE, DEVONSHIRE, BERMUDA MARCH 2025




## SHEET INDEX

SHEET	DESCRIPTION
ARCHITECTL	JRE / STRUCTURAL
TP.0	TITLE SHEET / LOCATION PLAN / SHEET LIST
S-100	ROOF PLAN
S-200	ELEVATIONS
S - 201	ELEVATIONS
S-300	SECTIONS

MAR.2025	1	ISSUE	ED FOR TENDER		
DEC. 2024	-	PROG	RESS ISSUE		
DATE	NO:		REVISION		
		ENG	NEERING CONSULTA	ANTS	
PROJECT: TYNES BAY SWRO PLANT 56 NORTH SHORE ROAD DEVONSHIRE PARISH, DV05					
TITLE: TITLE PAGE / LOCATION PLAN / DRAWING LIST					
SCALE:	AS SI	HOWN	JOB NO:	24-034	
DRAWN BY:		JC	DRAWING #:	B 6	
DATE: NOV	EMBE	₹ 2024		<b>P.</b> 0	
DRAWING SHEETS A	GS. DR RE HA	RAWING LF SCA	OWN IS FOR FULL S PLOTTED ON 1 LE SHOWN (1/4"= '-0" ON 11"x17" S	1"x17" 1'-0" ON	



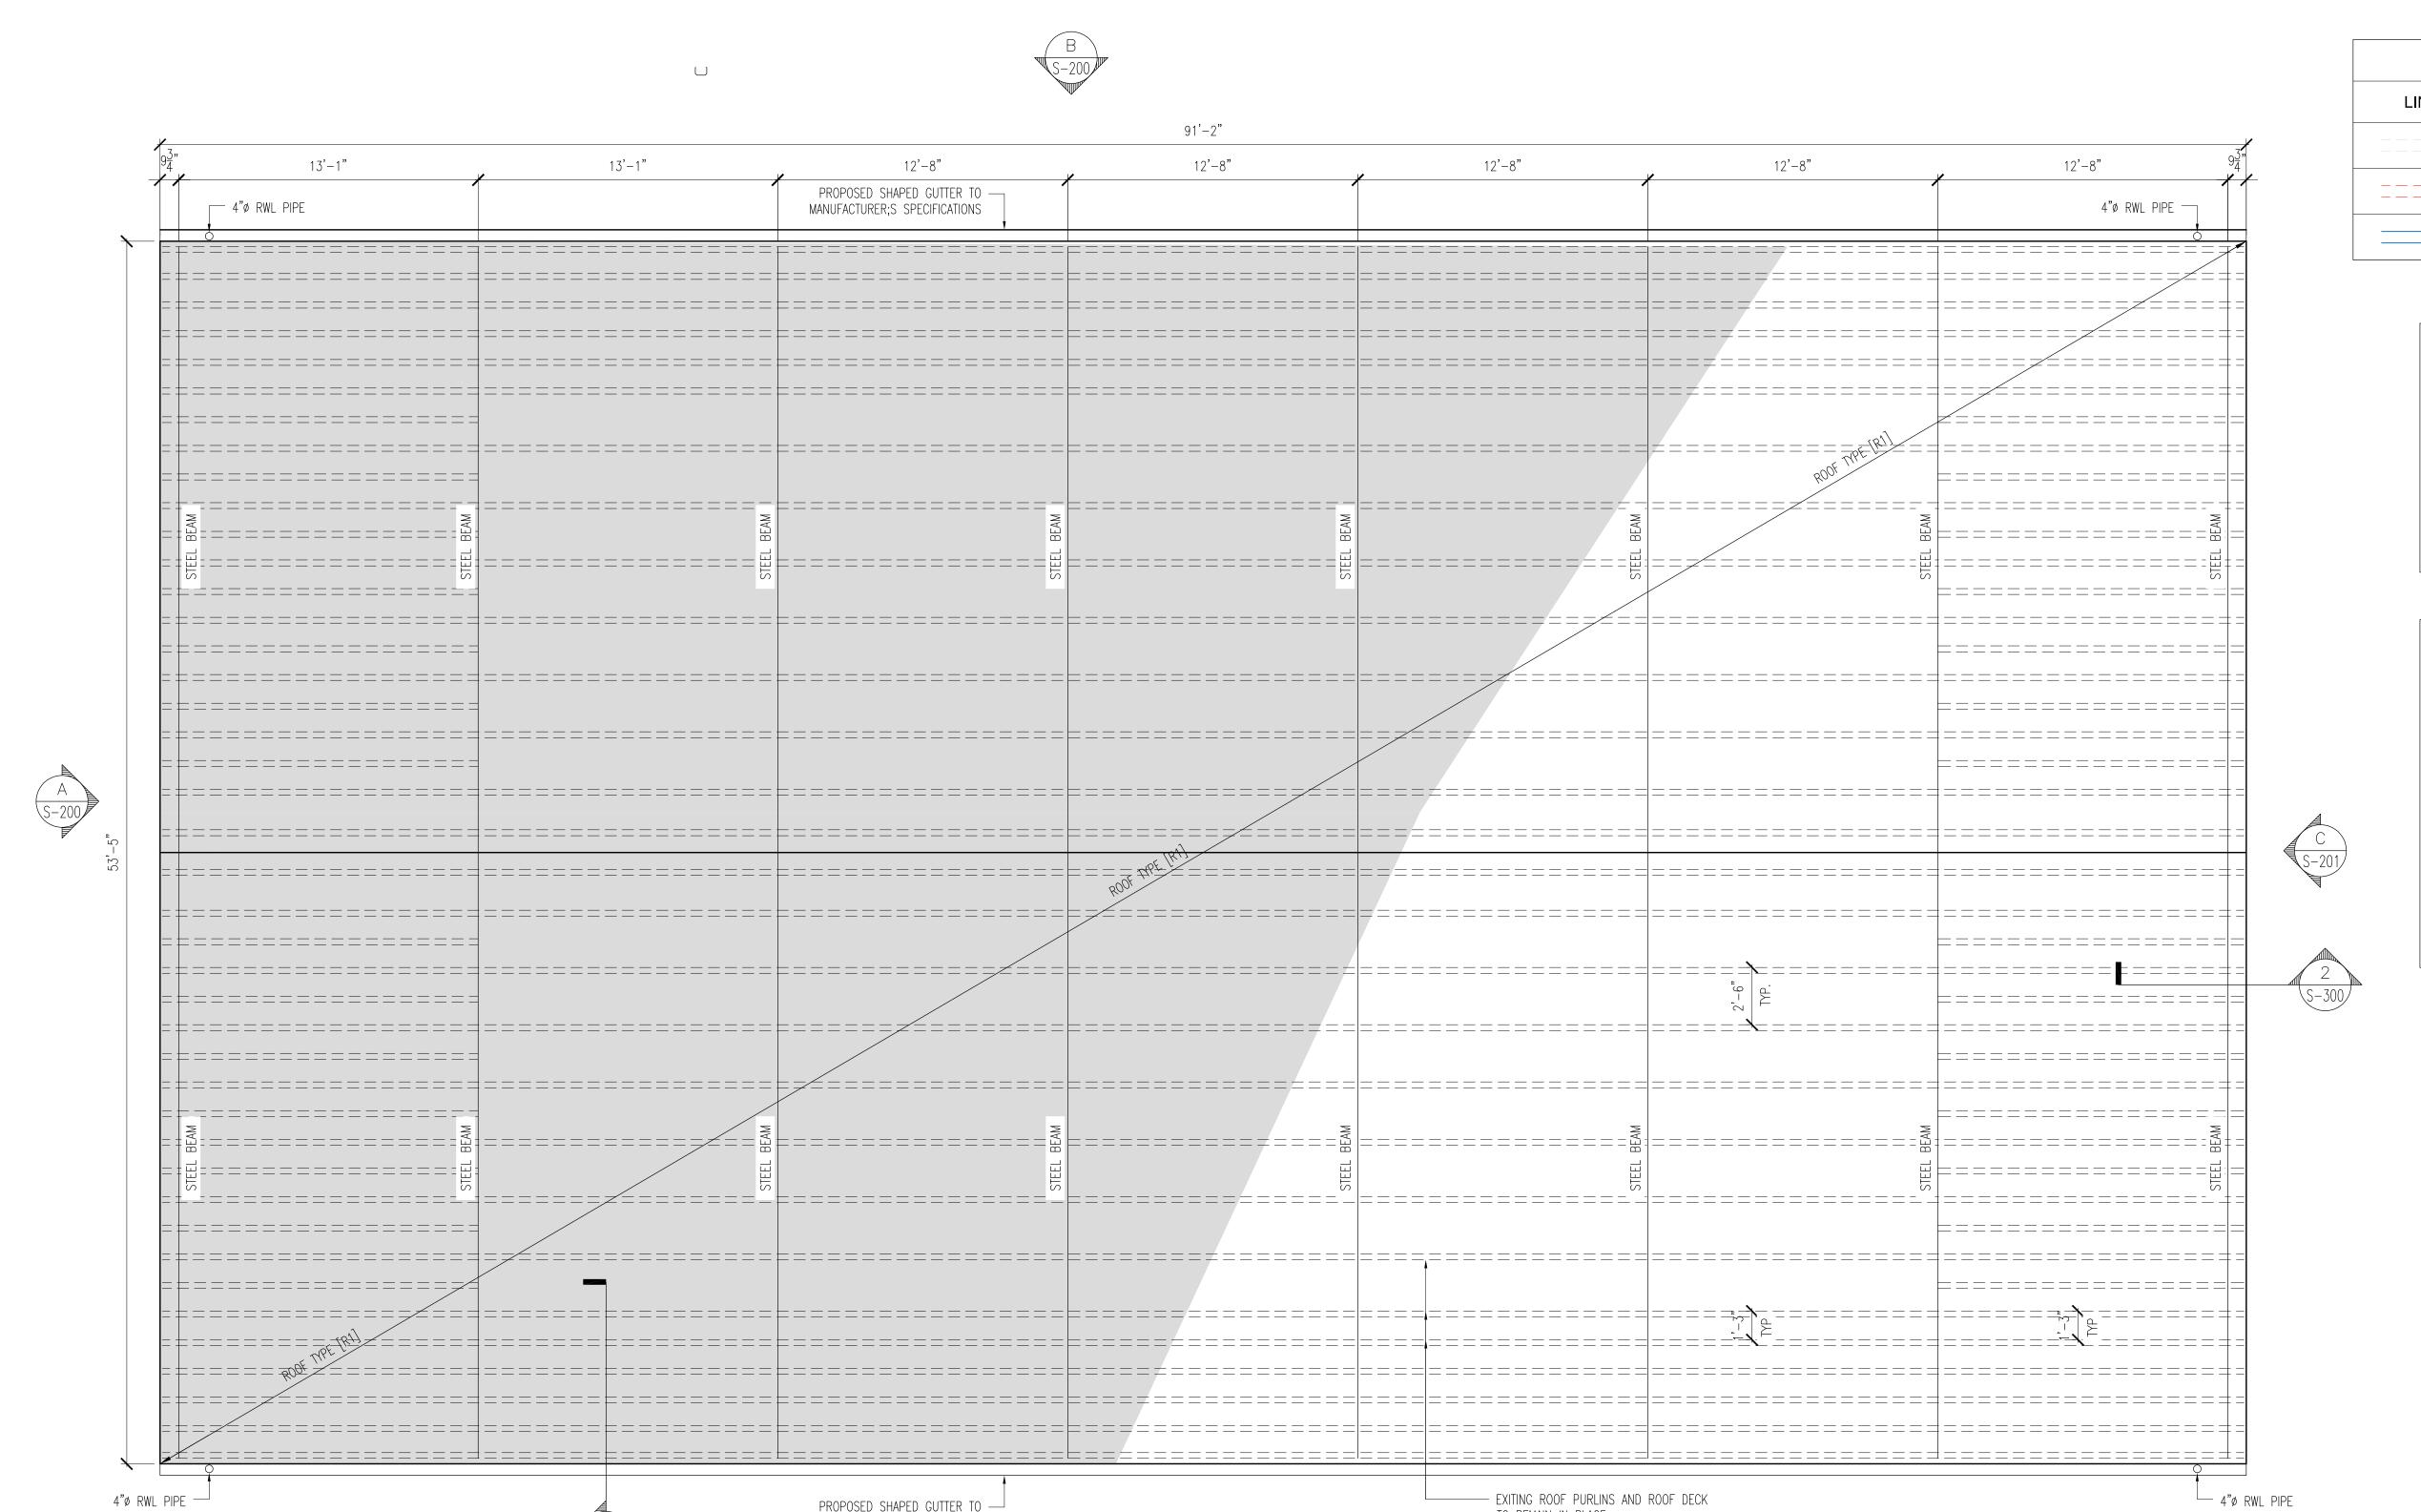

MANUFACTURER; S SPECIFICATIONS

**ROOF PLAN** 

NOTE:

SCALE: x" = 1'-0"

1. ALL DIMENSIONS TO BE CHECKED ON SITE BY CONTRACTOR.

3. REPAIR ALL RUST ON STRUCTURAL STEEL MEMBERS.

CONTRACTOR TO COORDINATE WITH ENGINEER.

2. ALL ROOF AND WALL CLADDING TO BE REMOVED AND REPLACED.

TO REMAIN IN PLACE

LEGEND				
LINES	DESCRIPTION			
	EXISTING STRUCTURAL STEEL MEMBERS TO REMAIN			
=====	EXISTING STRUCTURAL STEEL MEMBER TO BE REPLACED TO MATCH EXISTING SECTION. SEE CLADDING NOTE.			
	NEW STRUCTURAL MEMBER TO MATCH EXISTING. REFER TO WALL SPECIFICATION			

### ROOF SPECIFICATION

ROOF [R1]

Koor [Kr]	150MPH. ROOF CLADDING TO BE TYPE PBR, 26 GAUGE BY MBCI (METAL ROOF AND WALL SYSTEMS) OR EQUAL APPROVED. MAX SPAN OF CLADDING TO BE 3'-0". INSTALL TO MANUFACTURER'S INSTRUCTIONS.
	– FIXING TO BE #14 @ 8" C/C MAX STAINLESS STEEL BI-METALLIC SELF TAPPING SCREWS JT3 BY EJOT OR EQUAL APPROVED.
	<ul> <li>ALL EXISTING ROOF CLADDING AND FIXING TO BE REMOVED COMPLETELY. ANY RUST ON STEEL TO BE WIRE BRUSHED, CLEANED AND PAINTED WITH 2 COATS OF GALVAIZED PAINT</li> </ul>

- ROOF CLADDING TO RESIST 3-SECOND WIND GUSTS UP TO

### WALL SPECIFICATION

WALL [W1]	<ul> <li>WALL CLADDING TO BE TYPE PBR, 26 GAUGE BY MBCI (METAL ROOF AND WALL SYSTEMS) OR EQUAL APPROVED. MAX SPAN OF CLADDING TO BE 3'-0". INSTALL TO MANUFACTURER'S INSTRUCTIONS</li> </ul>
	<ul> <li>ALL FASTENED BACK TO EXISTING STEEL GIRT MEMBERS WIT #14 @ 8" C/C MAX STAINLESS STEEL BI-METALLIC SELF TAPPING SCREWS JT3 BY EJOT OR EQUAL APPROVED.</li> </ul>

ALL EXISTING WALL CLADDING AND FIXING TO BE REMOVED COMPLETELY. ANY RUST ON STEEL TO BE WIRE BRUSHED, CLEANED AND PAINTED WITH 2 COATS OF GALVAIZED PAINT

REPLACEMENT WALL GIRTS TO MATCH EXISTING OR TO BE TO BE

8" DEEP GALVANIZED 'Z' SECTION, 203Z76—218M BY CANAM OR EQUAL APPROVED AND INSTALLED BETWEEN EXISTING GIRTS.

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### PROJECT:

TYNES BAY SWRO PLANT 56 NORTH SHORE ROAD DEVONSHIRE PARISH, DV05


# TITLE: ROOF PLAN


SCALE: AS SHOWN JOB NO:

DRAWN BY: JC

DATE: NOVEMBER 2024

DRAWING SCALE SHOWN IS FOR FULL-SIZE DRAWINGS. DRAWINGS PLOTTED ON 11"x17" SHEETS ARE HALF SCALE SHOWN (1/4"=1'-0" ON 24"x36" SHEET = 1/8"=1'-0" ON 11"x17" SHEET)

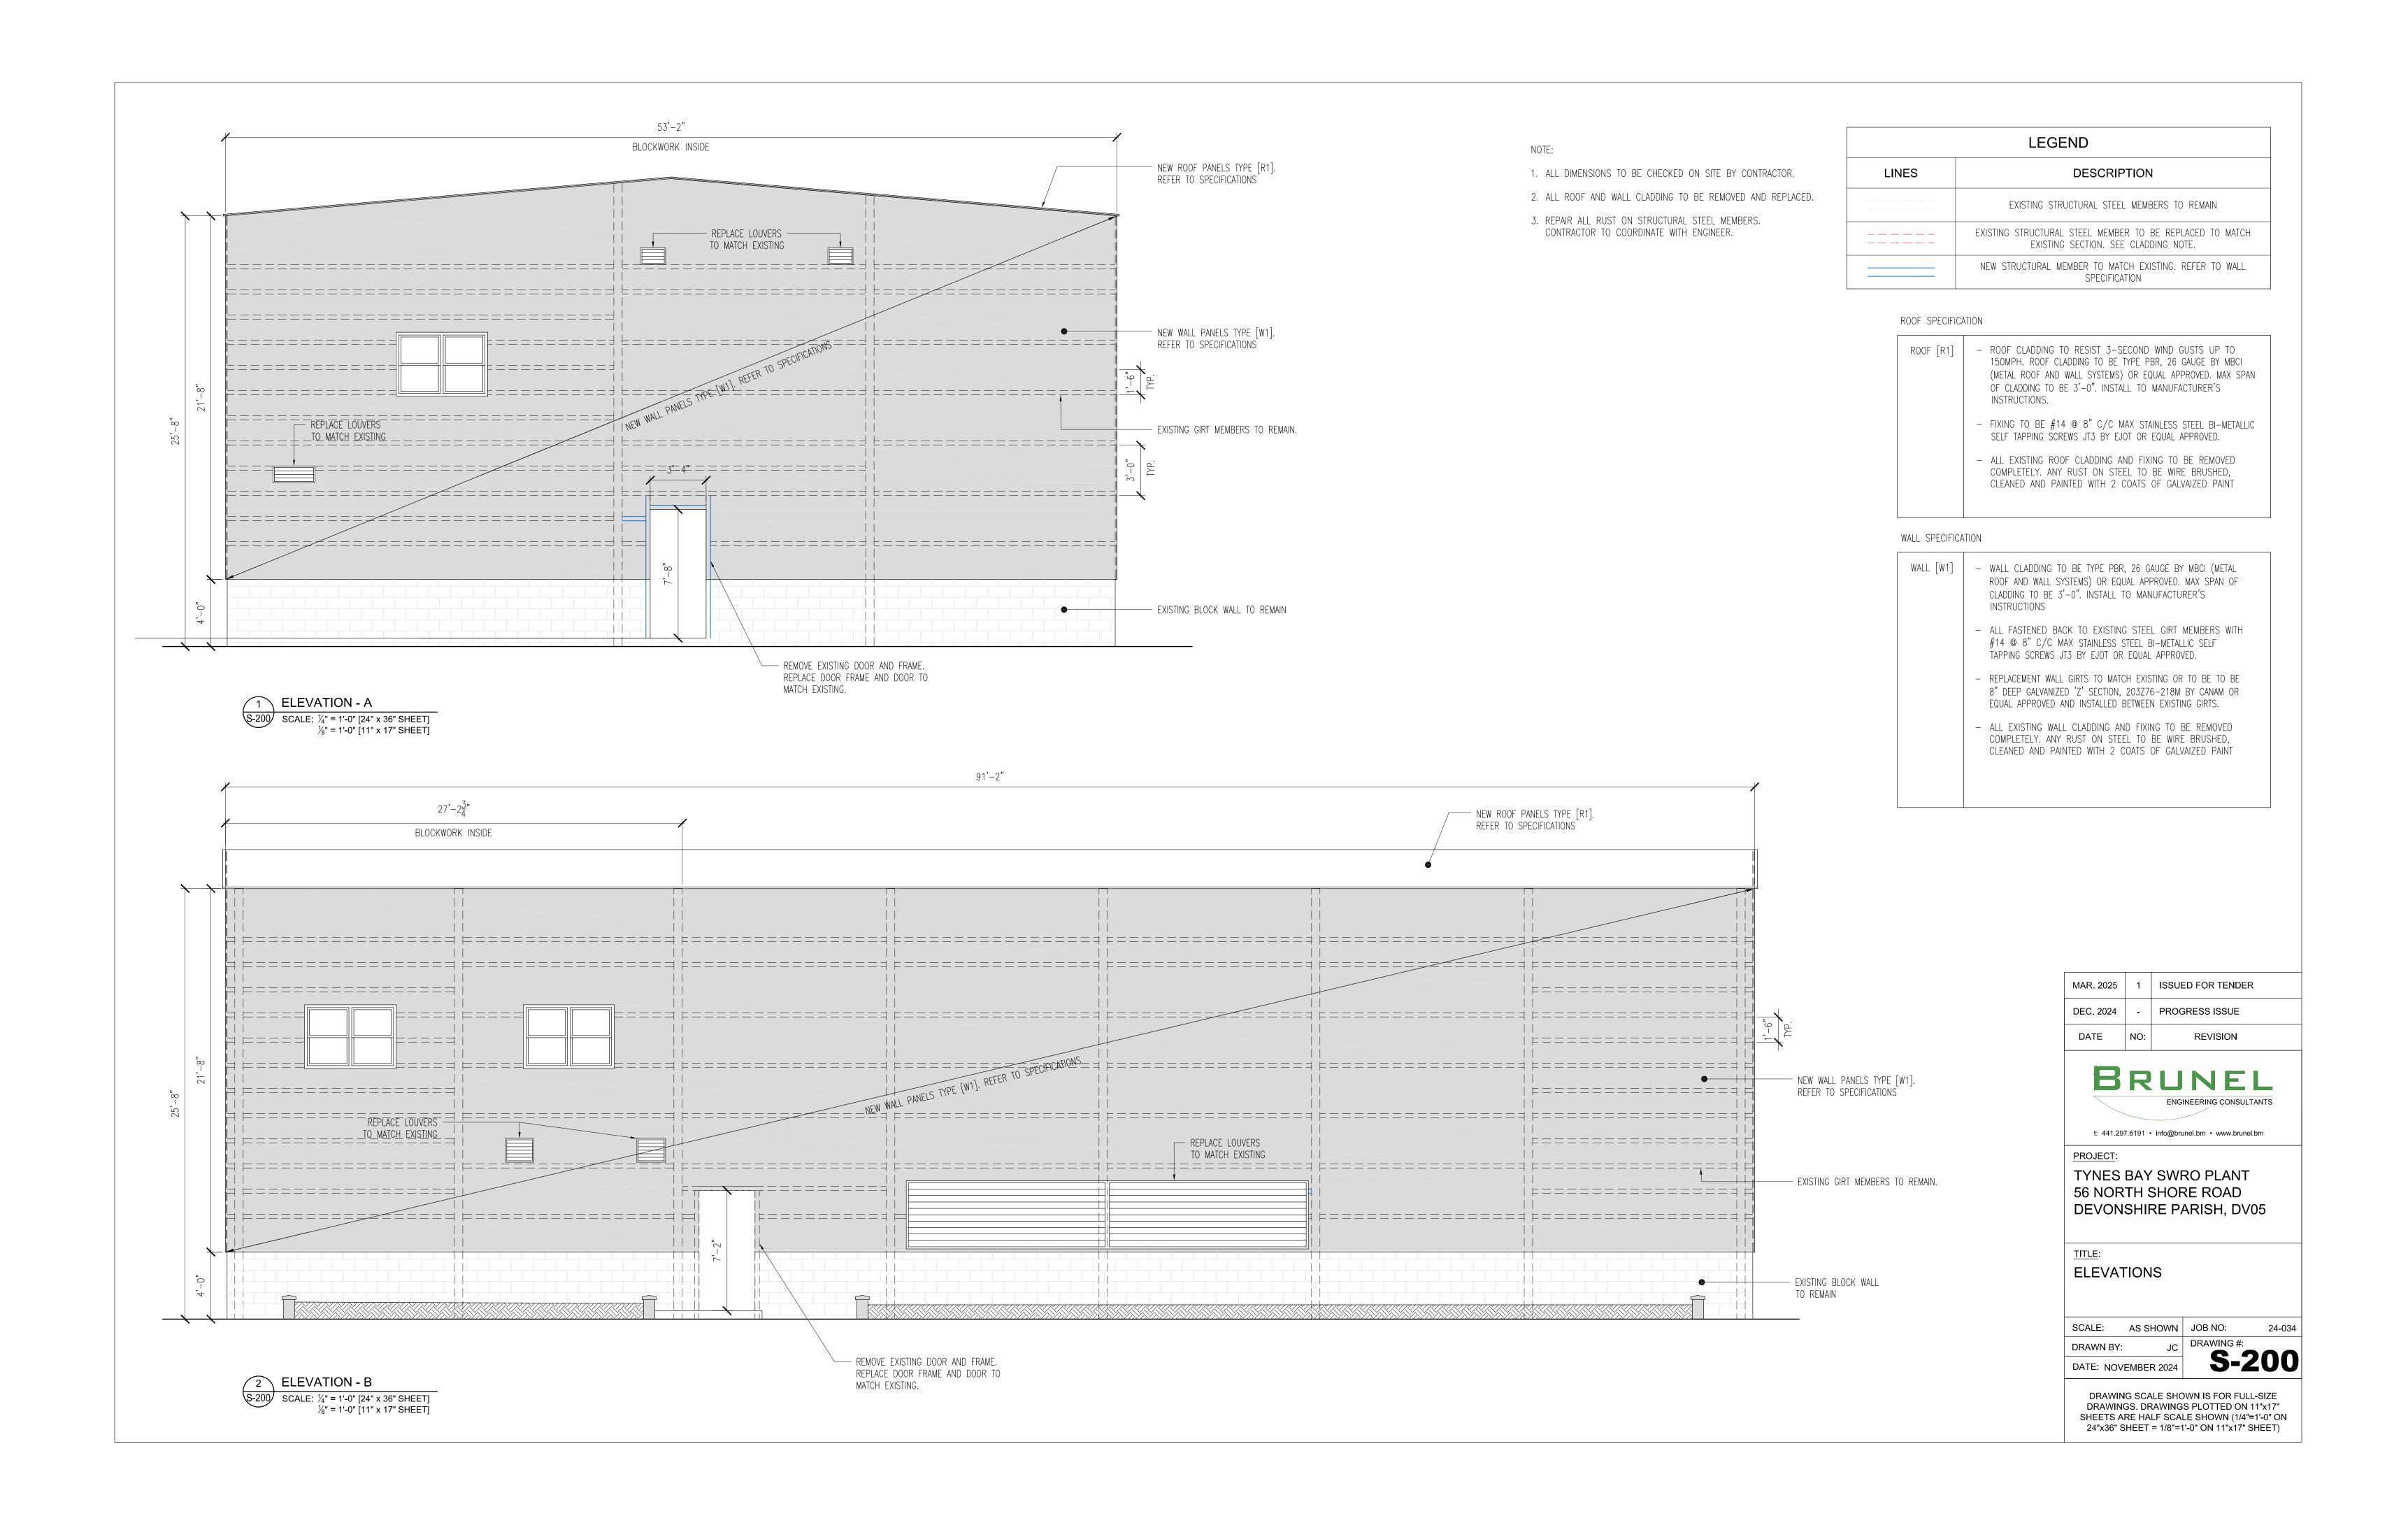

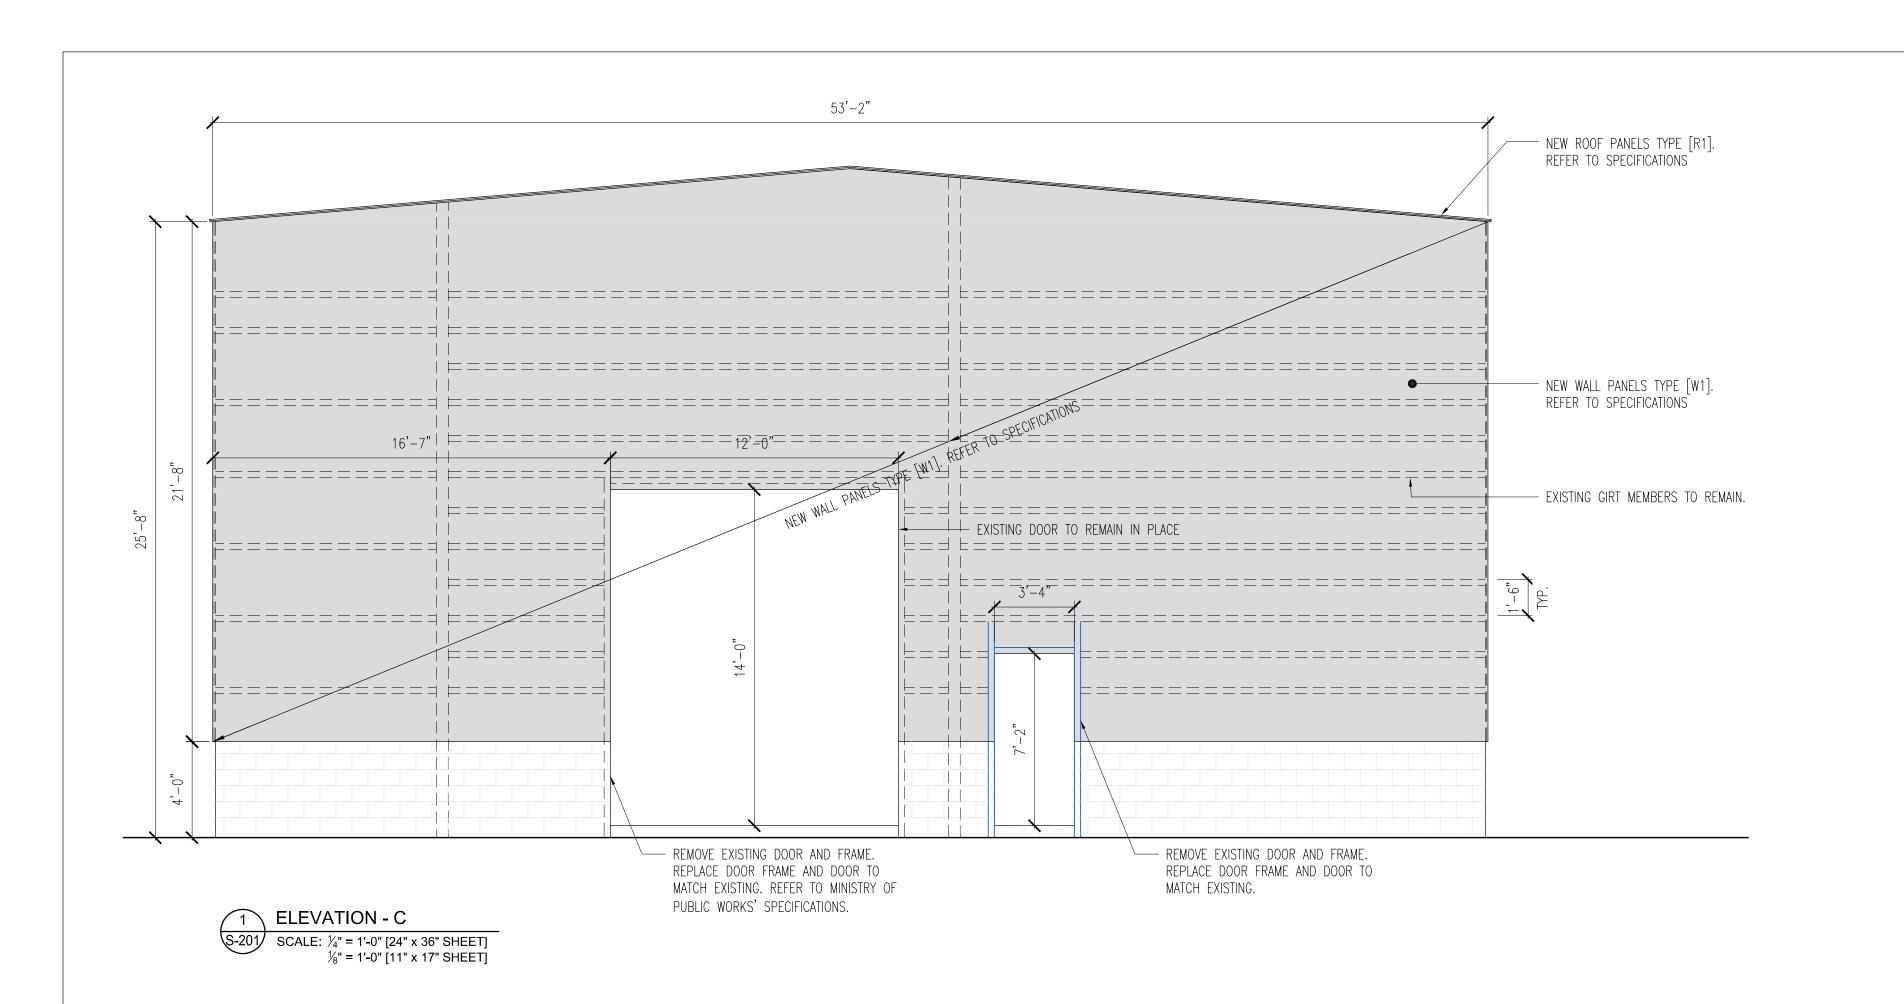

### NOTE:

- 1. ALL DIMENSIONS TO BE CHECKED ON SITE BY CONTRACTOR.
- 2. ALL ROOF AND WALL CLADDING TO BE REMOVED AND REPLACED.
- 3. REPAIR ALL RUST ON STRUCTURAL STEEL MEMBERS. CONTRACTOR TO COORDINATE WITH ENGINEER.

LEGEND			
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=====	EXISTING STRUCTURAL STEEL MEMBER TO BE REPLACED TO MATCH EXISTING SECTION. SEE CLADDING NOTE.		
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### ROOF SPECIFICATION

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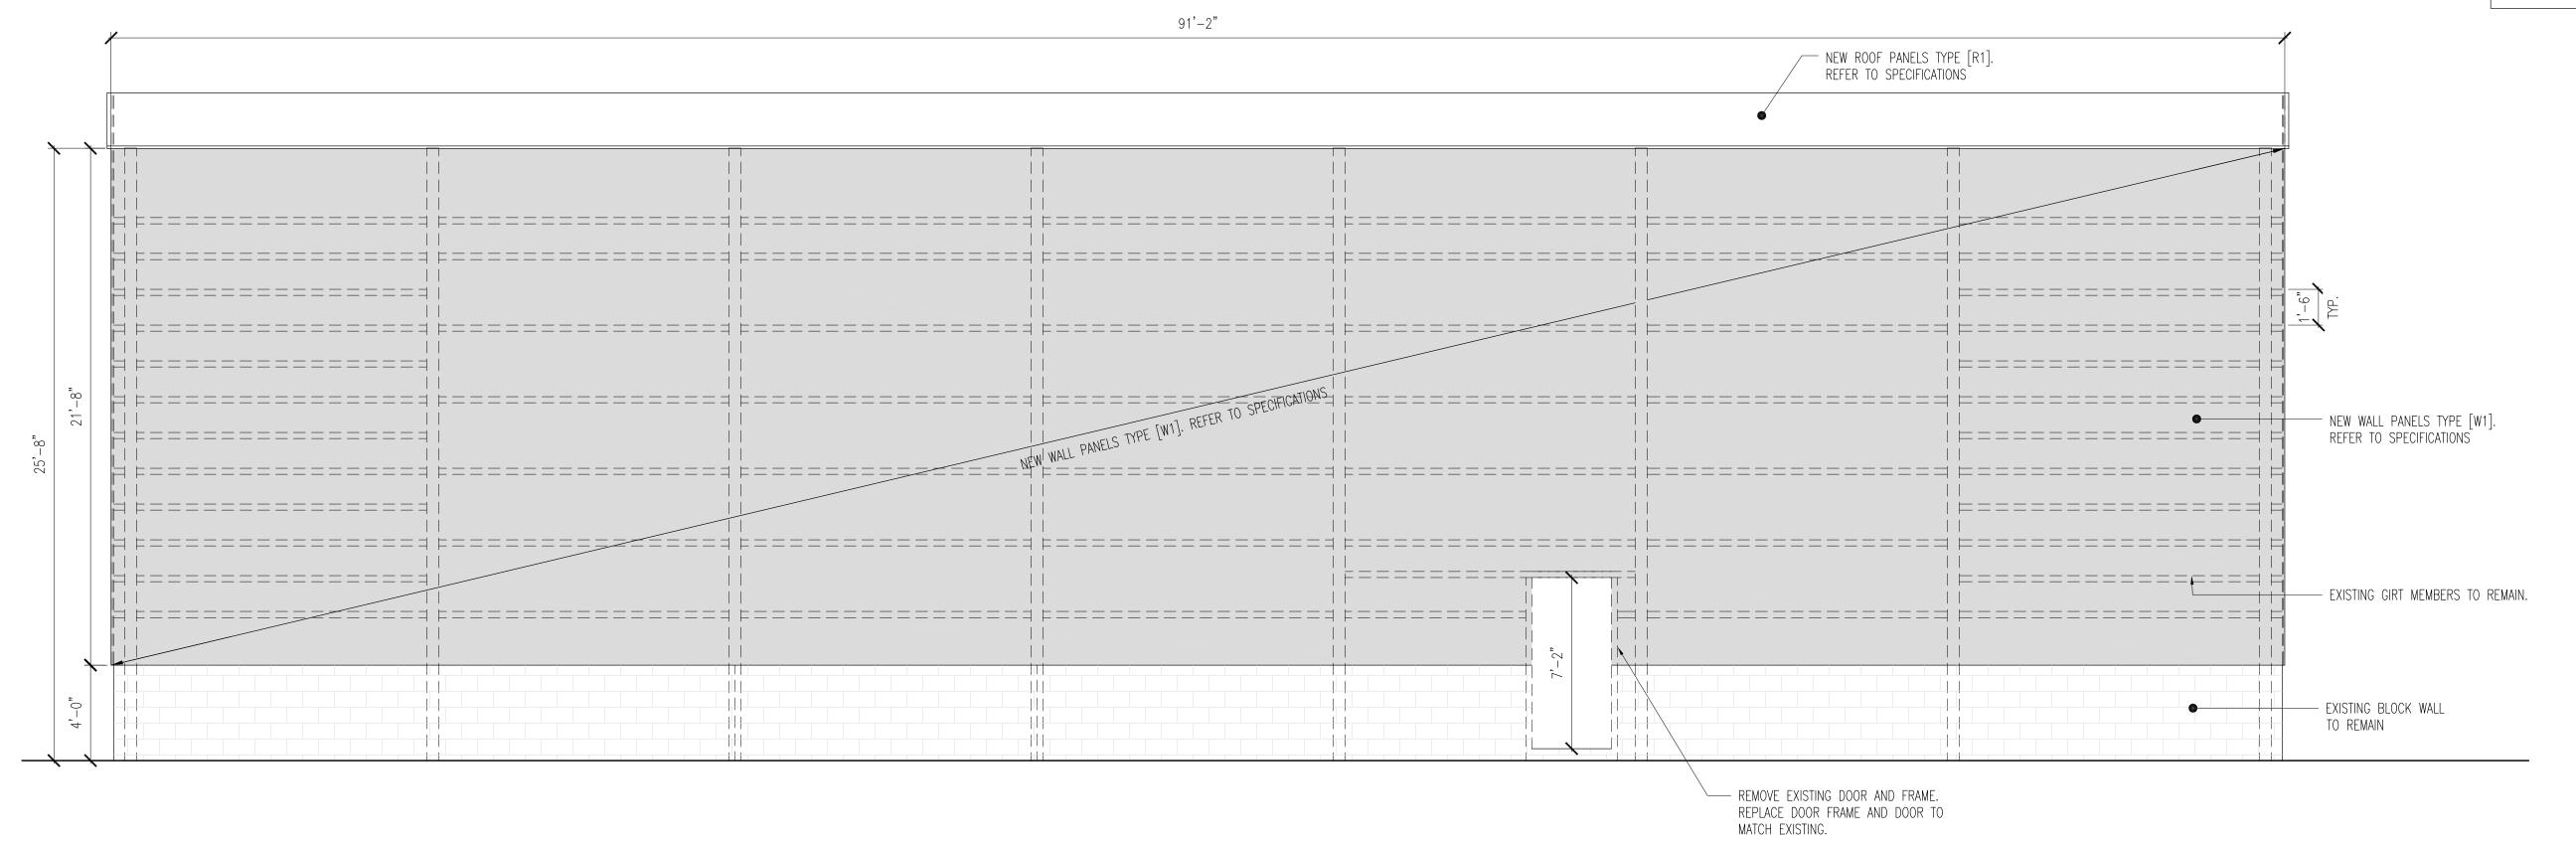
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PROJECT:

TYNES BAY SWRO PLANT 56 NORTH SHORE ROAD DEVONSHIRE PARISH, DV05

TITLE:
ELEVATIONS

SCALE: AS SHOWN JOB NO:

DRAWN BY: JC


DRAWING


JOB NO: 24

DRAWING #:

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PROJECT:

TYNES BAY SWRO PLANT 56 NORTH SHORE ROAD DEVONSHIRE PARISH, DV05

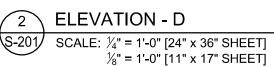TITLE:	
SECTIONS	

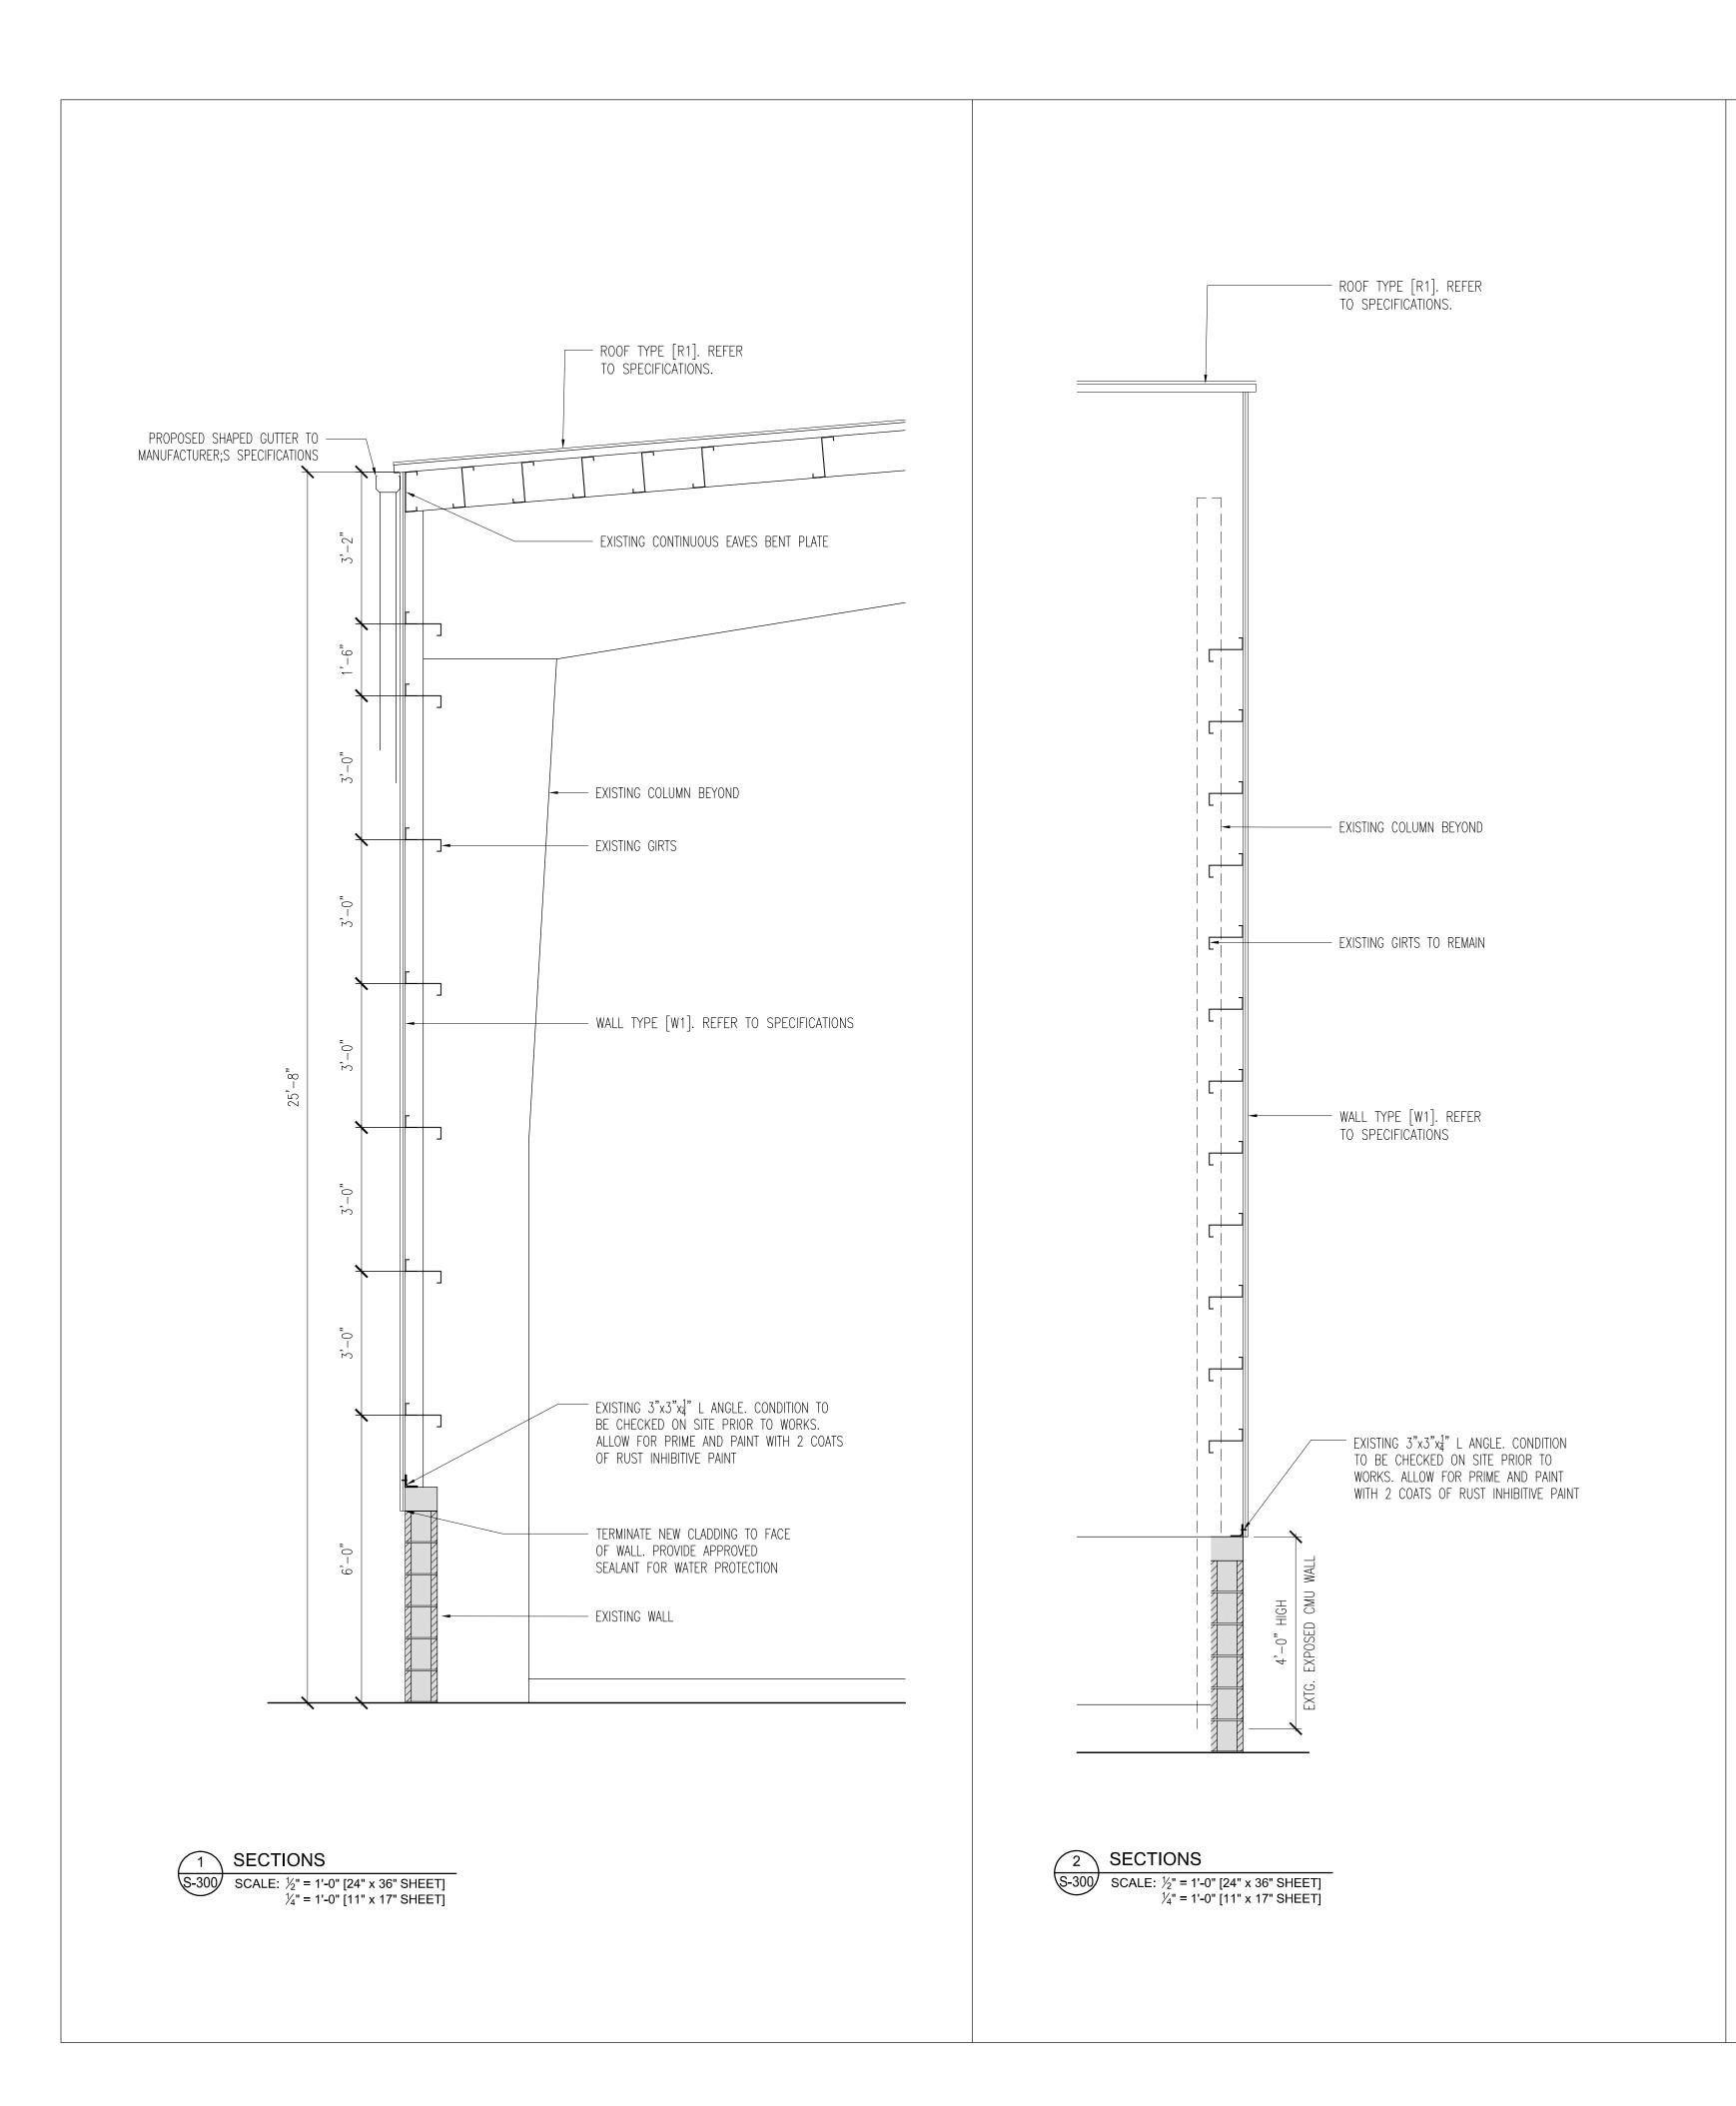 SCALE:
 AS SHOWN
 JOB NO:
 24-034

 DRAWN BY:
 JC
 DRAWING #:

 DATE:
 NOVEMBER 2024
 S-300

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