


# MARINE & PORTS EAST BROADWAY INTEGRATED PROJECTS AT FRONT STREET, CITY OF HAMILTON, BERMUDA JUNE 2020

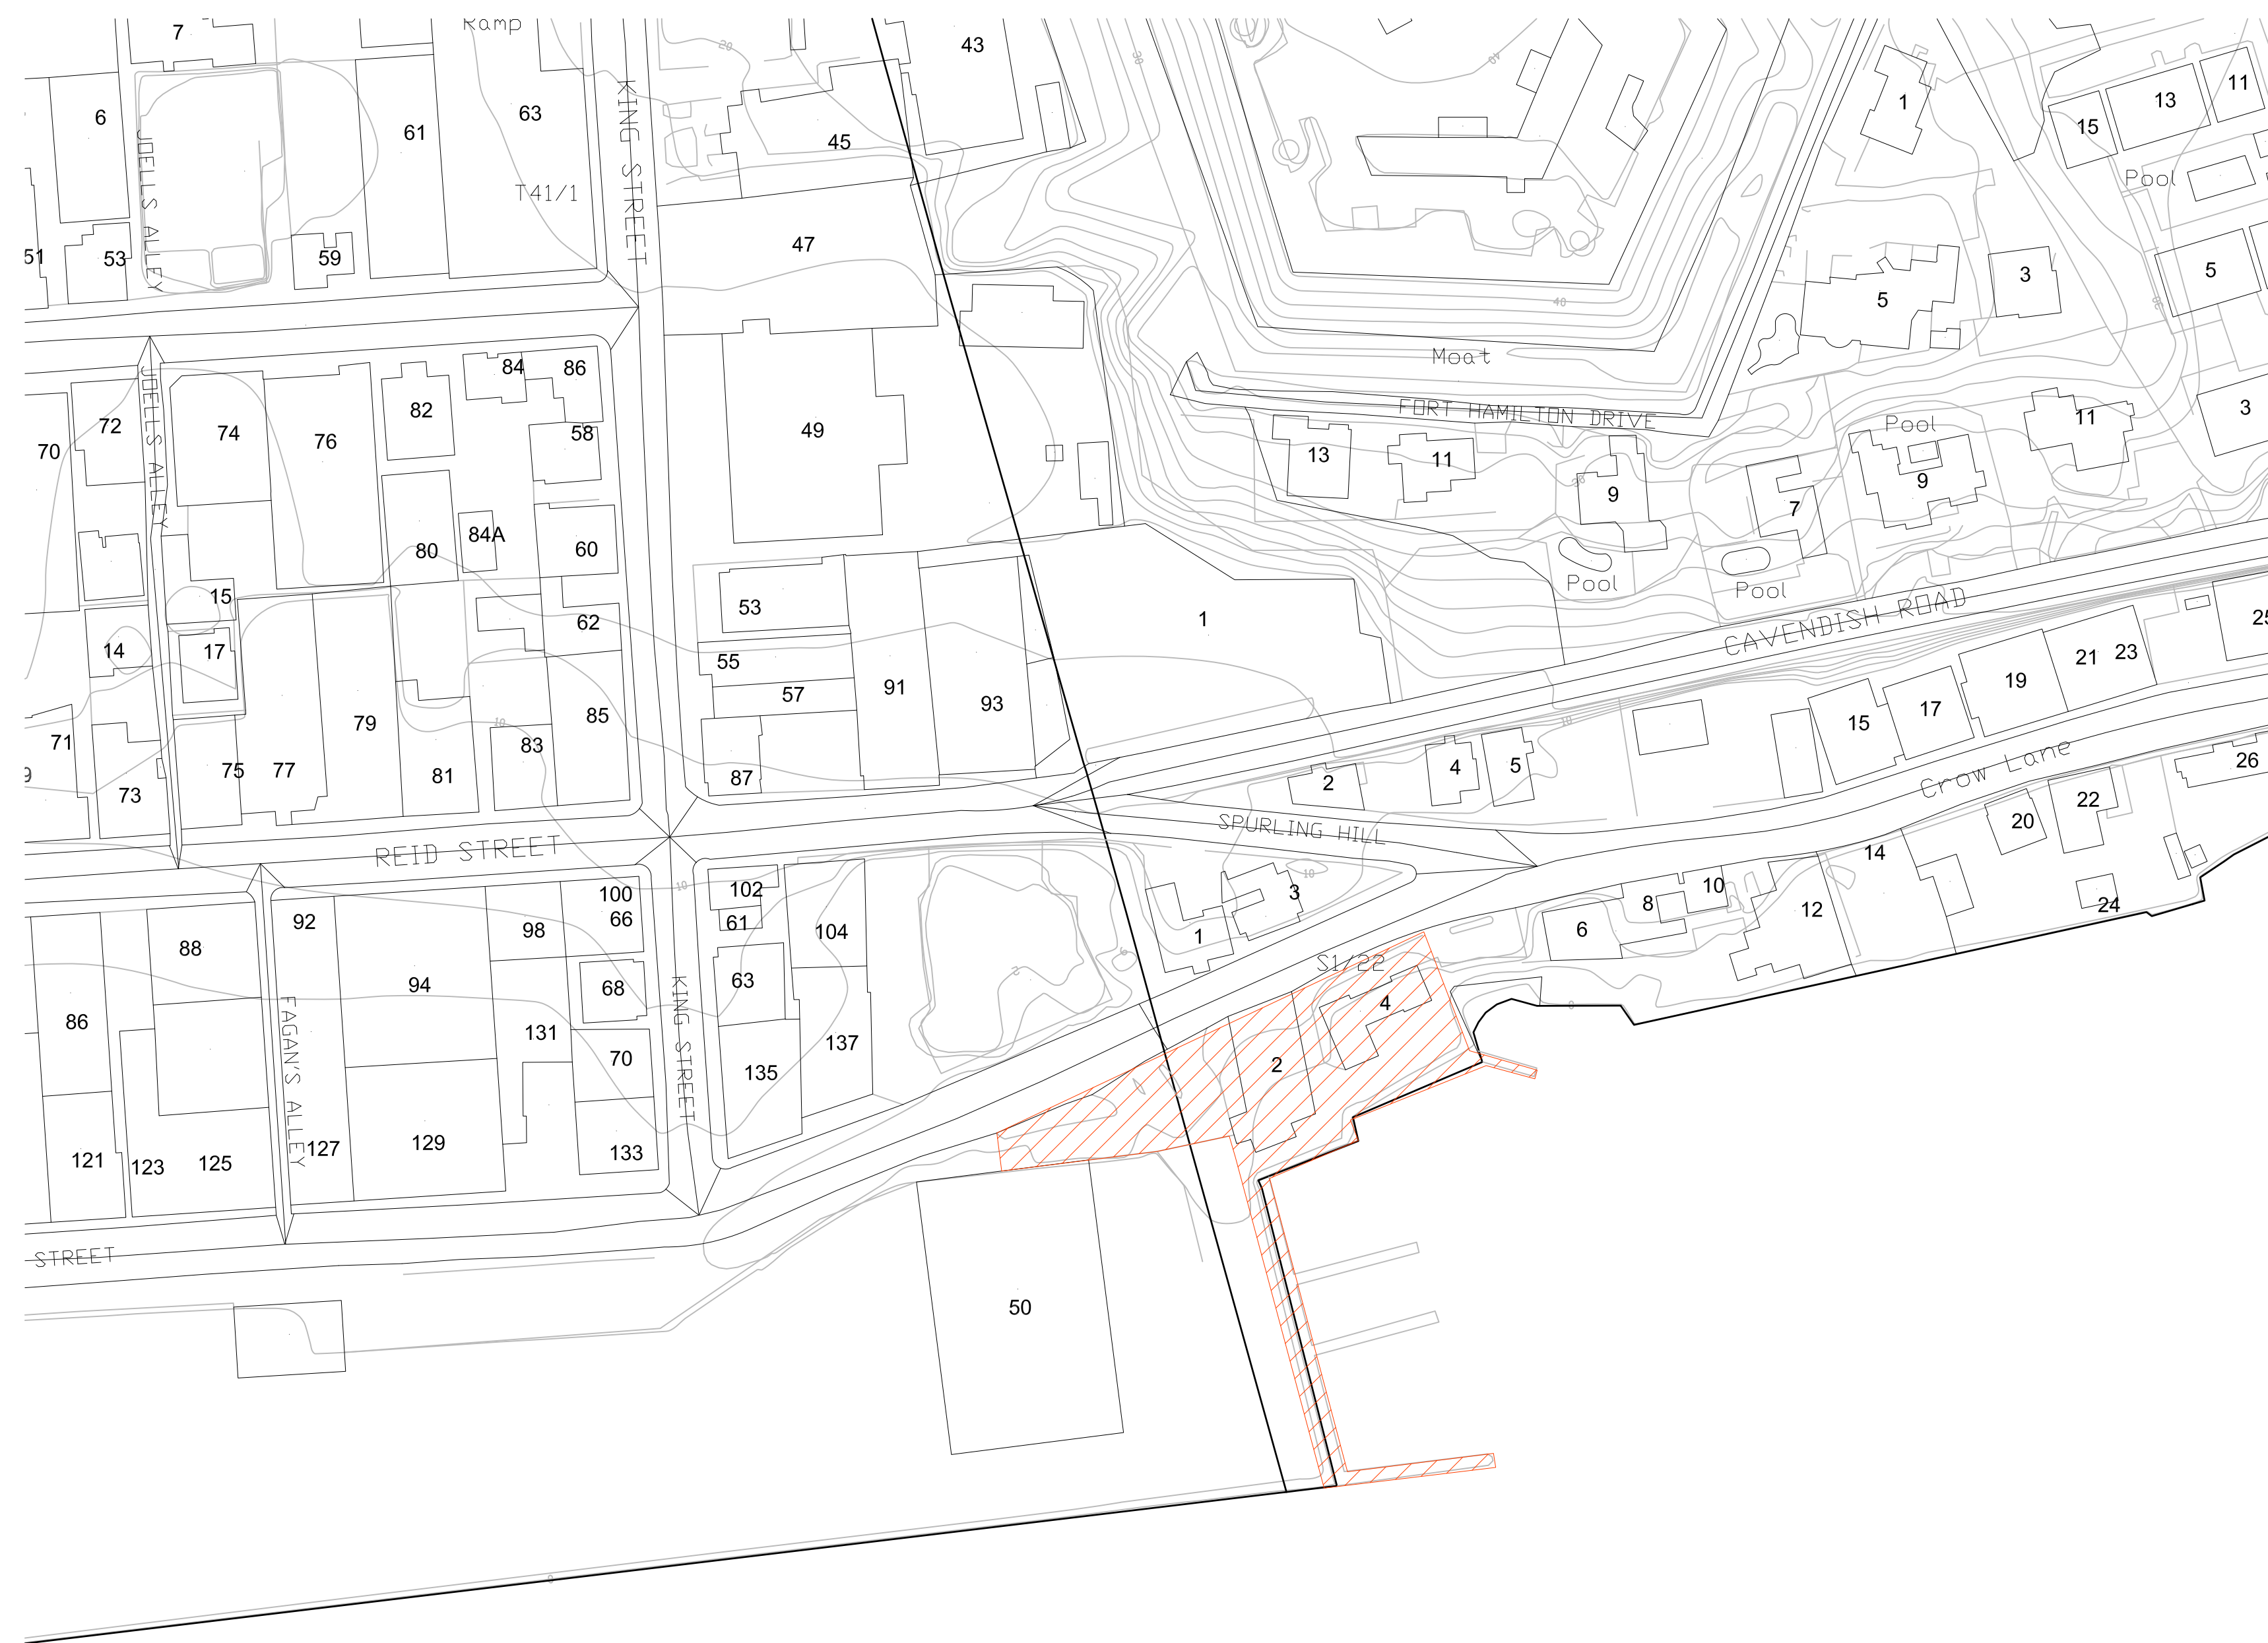

1 LOCATION PLAN  
TP.0 SCALE: N.T.S.

Xxx. 2019	-	ISSUED FOR
DATE	NO:	REVISION
 <small>t: 441.297.6191 • info@brunel.bm • www.brunel.bm</small>		
PROJECT:		
MARINE & PORTS EAST BROADWAY INTEGRATED PROJECTS		
TITLE:		
TITLE PAGE / LOCATION PLAN		
SCALE:	AS SHOWN	JOB NO: 20-031
DRAWN BY:	JC	DRAWING #:
DATE:	JUNE 2020	<b>TP.0</b>
DRAWING SCALE SHOWN IS FOR FULL-SIZE DRAWINGS. DRAWINGS PLOTTED ON 11"x17" SHEETS ARE HALF SCALE SHOWN (1/4"x1'-0" ON 24"x36" SHEET = 1/8"x1'-0" ON 11"x17" SHEET)		






1 EXISTING TANK FLOOR PLAN  
 EX.1 SCALE: 1/8" = 1'-0" (11x17 SHEET)  
 1/4" = 1'-0" (24x36 SHEET)

Xxx. 2019	-	ISSUED FOR
DATE	NO:	REVISION
 <small>t: 441.297.6191 • info@brunel.bm • www.brunel.bm</small>		
PROJECT:		
MARINE & PORTS EAST BROADWAY INTEGRATED PROJECTS		
TITLE:		
EXISTING TANK FLOOR PLAN		
SCALE:	AS SHOWN	JOB NO: 20-031
DRAWN BY:	JC	DRAWING #:
DATE:	JUNE 2020	<b>EX.1</b>
DRAWING SCALE SHOWN IS FOR FULL-SIZE DRAWINGS. DRAWINGS PLOTTED ON 11"x17" SHEETS ARE HALF SCALE SHOWN (1/4"=1'-0" ON 24"x36" SHEET = 1/8"=1'-0" ON 11"x17" SHEET)		



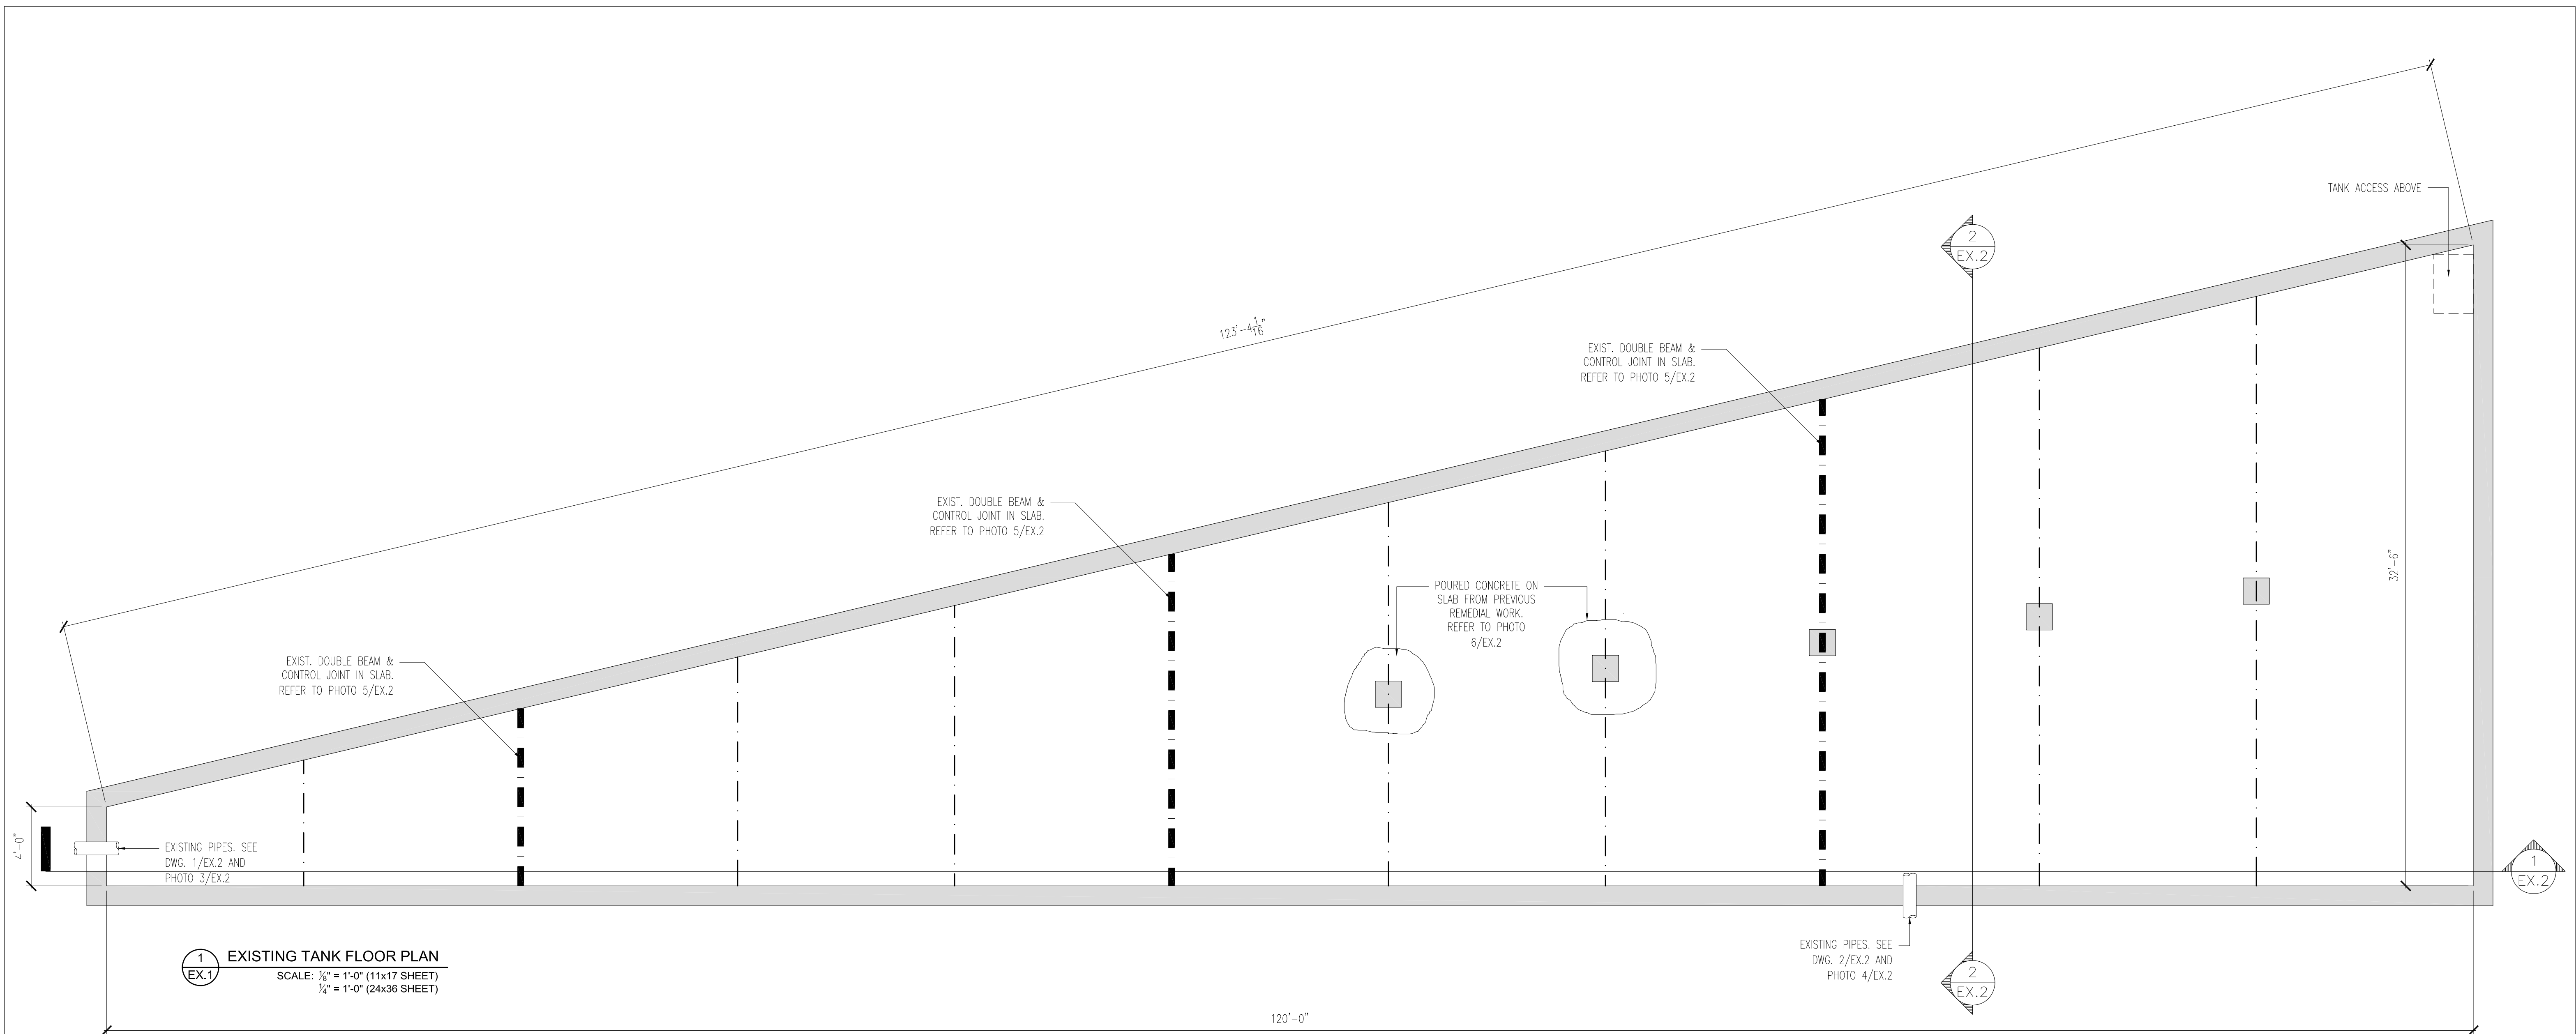

2 EX.1 PHOTO 1  
SCALE: N.T.S



3 EX.1 PHOTO 2  
SCALE: N.T.S




4 EX.1 PHOTO 3  
SCALE: N.T.S




5 EX.1 PHOTO 4  
SCALE: N.T.S

Xxx, 2019	-	ISSUED FOR
DATE	NO:	REVISION
<small>t: 441.297.6191 • info@brunel.bm • www.brunel.bm</small>		
PROJECT:		
MARINE & PORTS EAST BROADWAY INTEGRATED PROJECTS		
TITLE:		
EXISTING TANK FLOOR PLAN & PHOTOS		
SCALE:	AS SHOWN	JOB NO: 20-031
DRAWN BY:	JC	DRAWING #:
DATE:	JUNE 2020	<b>EX.1</b>
DRAWING SCALE SHOWN IS FOR FULL-SIZE DRAWINGS. DRAWINGS PLOTTED ON 11"x17" SHEETS ARE HALF SCALE SHOWN (1/4"=1'-0" ON 24"x36" SHEET = 1/8"=1'-0" ON 11"x17" SHEET)		



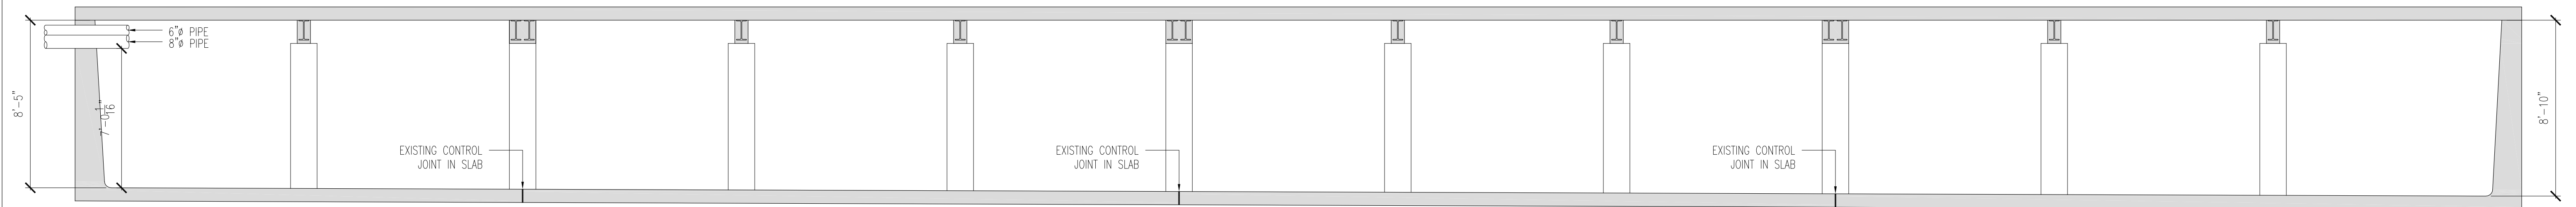

1 EXISTING TANK SECTION  
EX.2 SCALE: 1/8" = 1'-0" (11x17 SHEET)  
1/4" = 1'-0" (24x36 SHEET)

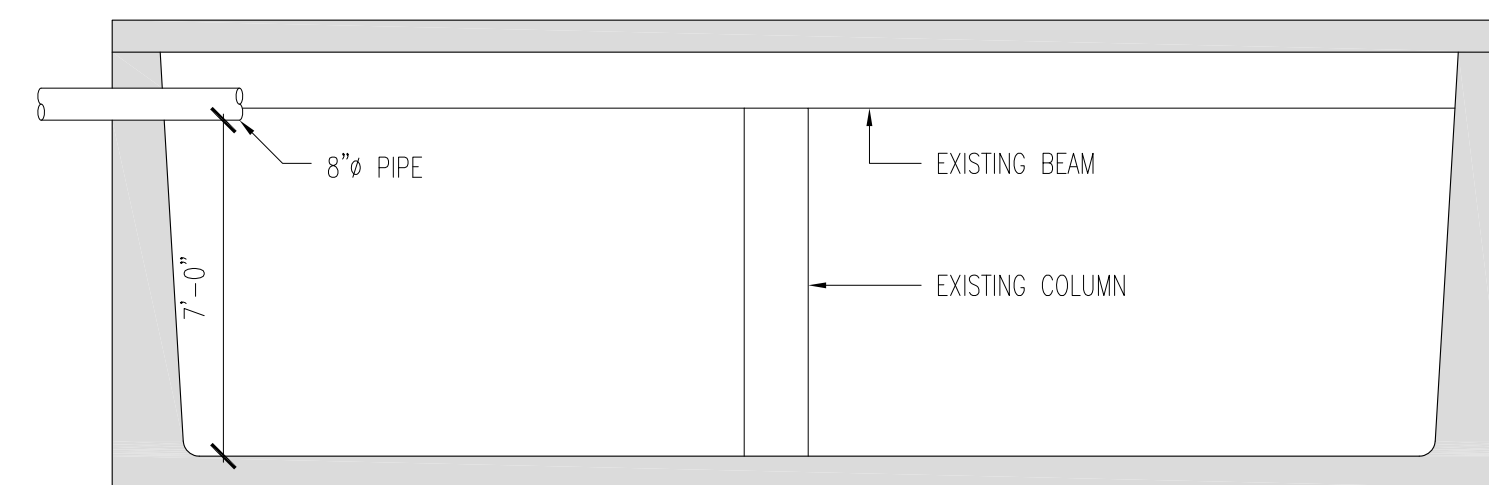

2 EXISTING TANK SECTION  
EX.2 SCALE: 1/8" = 1'-0" (11x17 SHEET)  
1/4" = 1'-0" (24x36 SHEET)



3 PHOTO 5  
EX.2 SCALE: N.T.S




4 PHOTO 6  
EX.2 SCALE: N.T.S



5 PHOTO 7  
EX.2 SCALE: N.T.S



6 PHOTO 8  
EX.2 SCALE: N.T.S

Xxx, 2019	-	ISSUED FOR
DATE	NO:	REVISION
 <small>t: 441.297.6191 • info@brunel.bm • www.brunel.bm</small>		
PROJECT:		
MARINE & PORTS EAST BROADWAY INTEGRATED PROJECTS		
TITLE:		
EXISTING TANK SECTIONS		
SCALE:	AS SHOWN	JOB NO: 20-031
DRAWN BY:	JC	DRAWING #:
DATE:	JUNE 2020	<b>EX.2</b>
DRAWING SCALE SHOWN IS FOR FULL-SIZE DRAWINGS. DRAWINGS PLOTTED ON 11"x17" SHEETS ARE HALF SCALE SHOWN (1/4"=1'-0" ON 24"x36" SHEET = 1/8"=1'-0" ON 11"x17" SHEET)		






FUEL & DIESEL DISTRIBUTION LEGEND	
	EXISTING BUILDINGS
	ASPHALT SURFACE
	GRASS / VEGETATION SURFACE
	FLOATING DOCK
	OCEAN
	EXISTING FUEL PIPING
	EXISTING DIESEL PIPING
	PROPOSED FUEL PIPING
	PROPOSED DIESEL PIPING
	ABANDONED DISTRIBUTION PIPING

**1**  
**S1.1**

**PROPOSED FUEL & DIESEL - SITE PLAN**  
 SCALE: 3/32" = 1'-0" (11x17 SHEET)  
 3/64" = 1'-0" (24x36 SHEET)

JUNE 2020	-	ISSUED TO CLIENT
DATE	NO:	REVISION
 t: 441.297.6191 • info@brunel.bm • www.brunel.bm		
<b>PROJECT:</b> MARINE & PORTS EAST BROADWAY INTEGRATED PROJECTS		
<b>TITLE:</b> PROPOSED FUEL & DIESEL DESIGN LAYOUT		
SCALE:	AS SHOWN	JOB NO: 20-031
DRAWN BY:	JC	DRAWING #:
DATE:	JUNE 2020	<b>S1.1</b>
<small>DRAWING SCALE SHOWN IS FOR FULL-SIZE DRAWINGS. DRAWINGS PLOTTED ON 11"x17" SHEETS ARE HALF SCALE SHOWN (1/4"=1'-0" ON 24"x36" SHEET = 1/8"=1'-0" ON 11"x17" SHEET)</small>		

NOTE:  
THIS IS A SCHEMATIC DESIGN TO VISUAL SHOW  
WHAT IS REQUIRED, BUT CONTACTOR CAN CHANGE  
DESIGN LAYOUT TO FIT THEIR PROPOSED EQUIPMENT

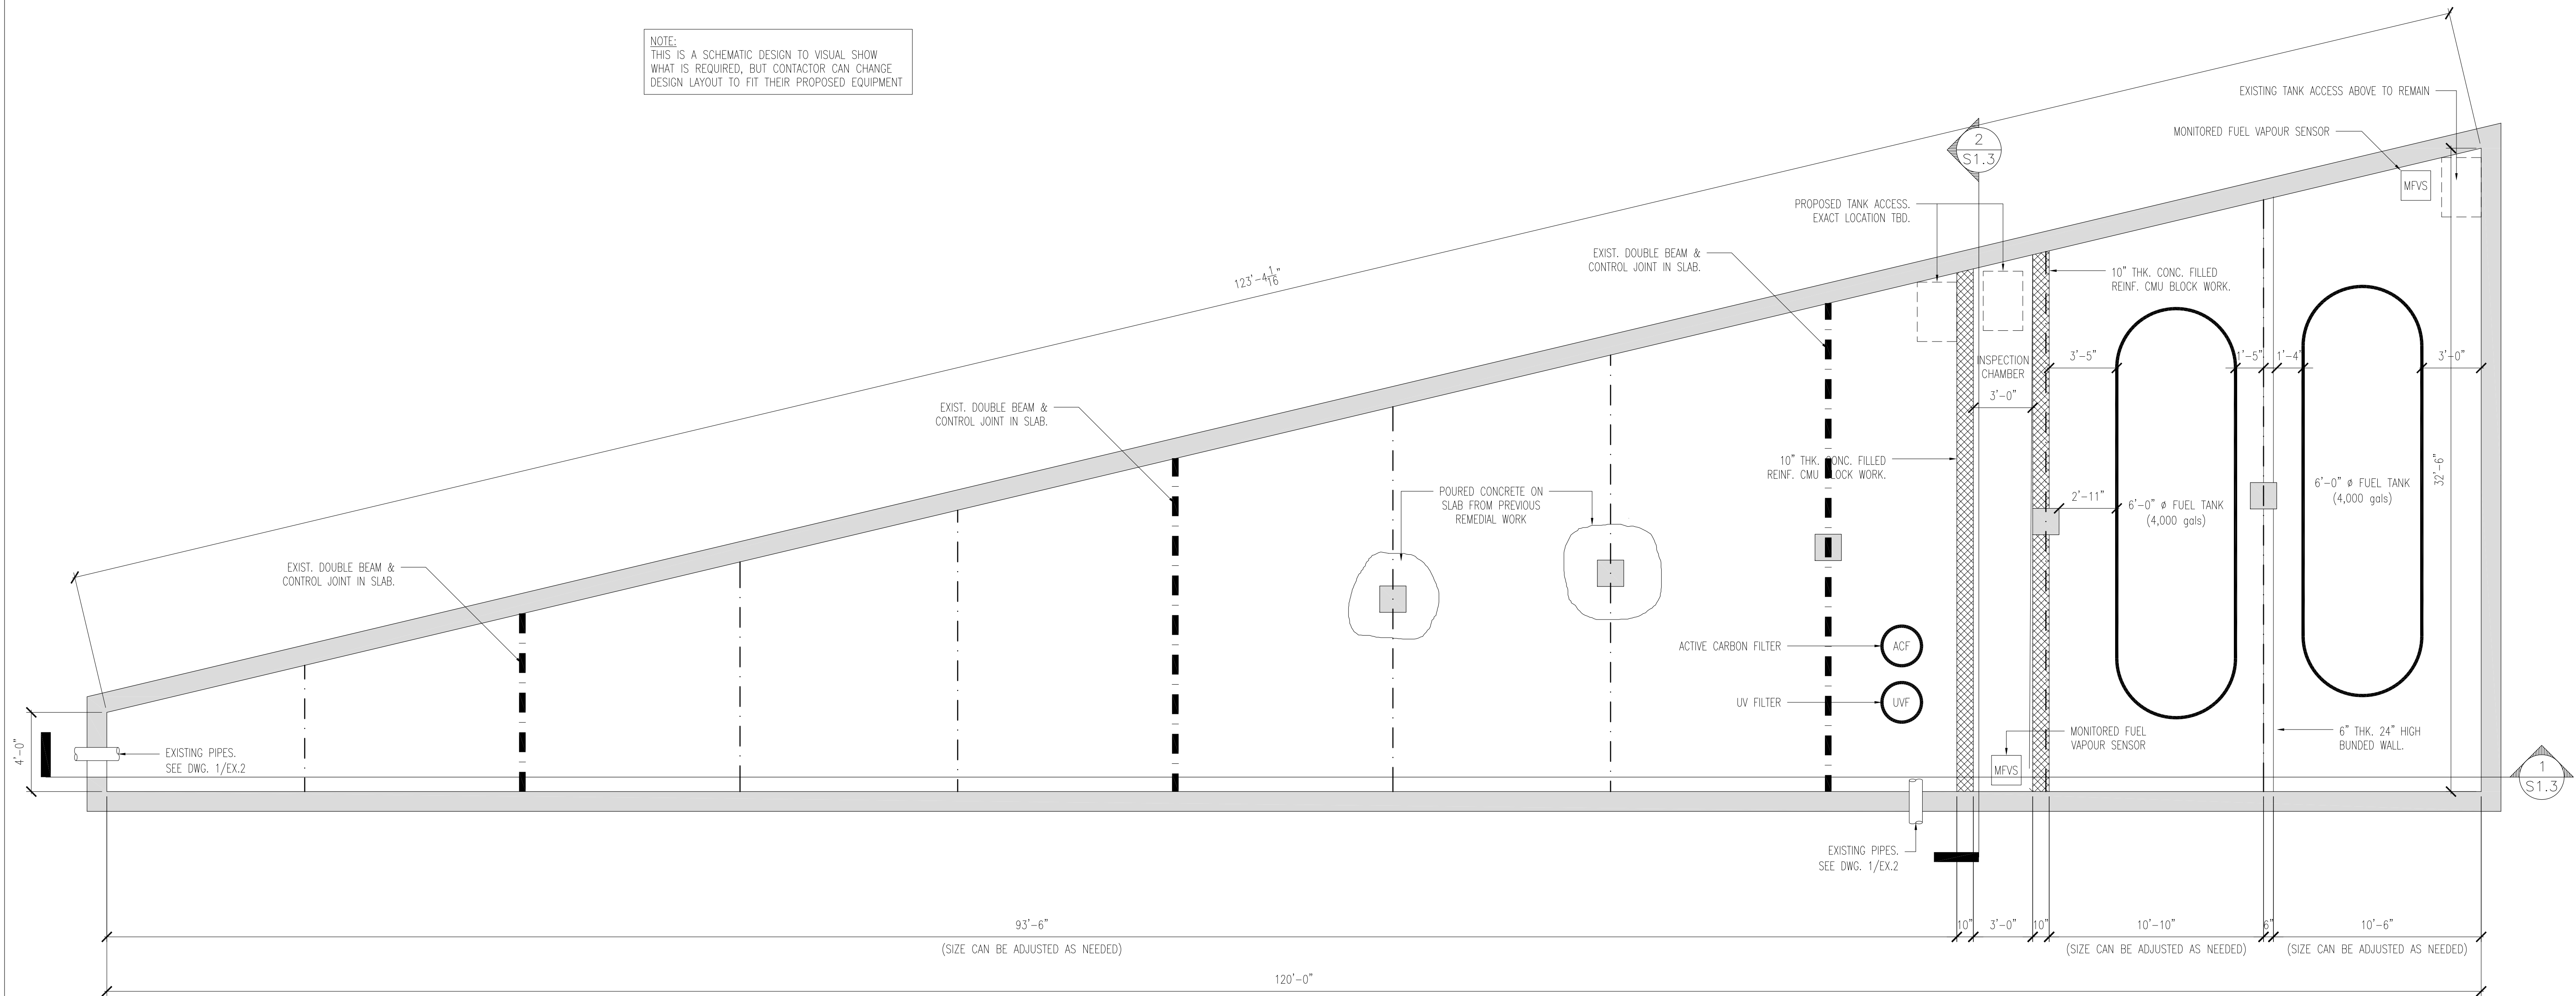

**1** PROPOSED TANK FLOOR PLAN  
SCALE:  $\frac{1}{8}" = 1'-0"$  (11x17 SHEET)  
 $\frac{1}{4}" = 1'-0"$  (24x36 SHEET)

Xxx. 2019	-	ISSUED FOR
DATE	NO:	REVISION

**BRUNEL**  
ENGINEERING CONSULTANTS

t: 441.297.6191 • info@brunel.bm • www.brunel.bm

PROJECT:  
MARINE & PORTS  
EAST BROADWAY  
INTEGRATED PROJECTS


TITLE:  
PROPOSED TANK FLOOR PLAN

SCALE:	AS SHOWN	JOB NO:	20-031
DRAWN BY:	JC	DRAWING #:	<b>S1.2</b>
DATE:	JUNE 2020		


DRAWING SCALE SHOWN IS FOR FULL-SIZE  
DRAWINGS. DRAWINGS PLOTTED ON 11"x17"  
SHEETS ARE HALF SCALE SHOWN (1/4"=1'-0" ON  
24"x36" SHEET = 1/8"=1'-0" ON 11"x17" SHEET)




NOTE:  
THIS IS A SCHEMATIC DESIGN TO VISUAL SHOW  
WHAT IS REQUIRED, BUT CONTACTOR CAN CHANGE  
DESIGN LAYOUT TO FIT THEIR PROPOSED EQUIPMENT

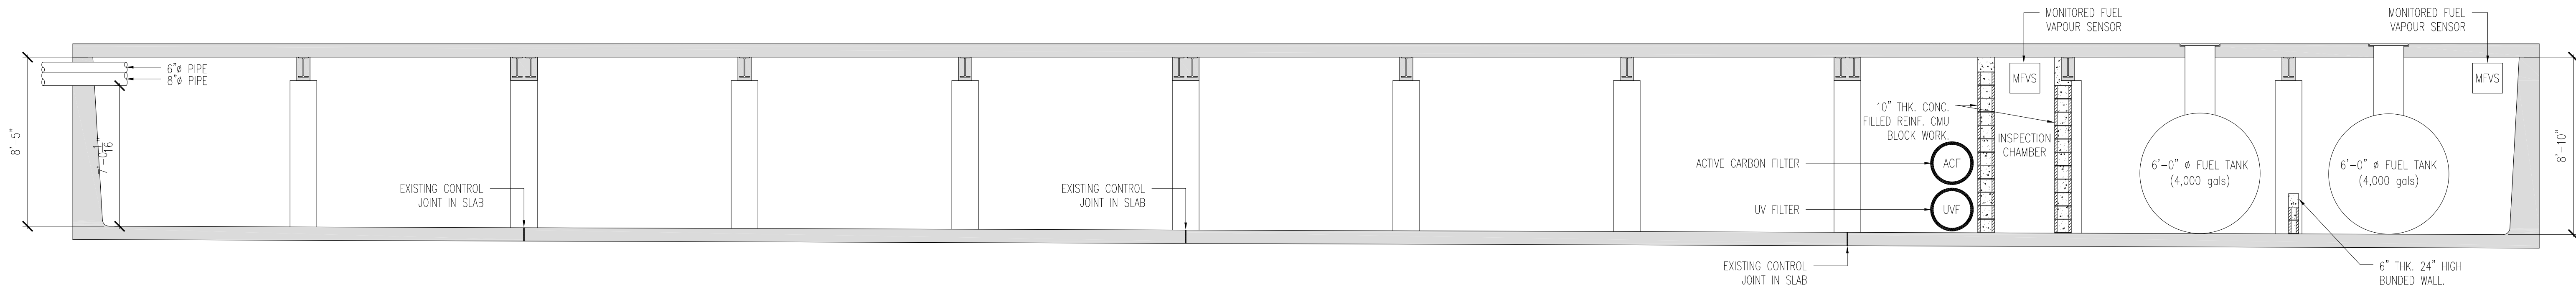

**1 PROPOSED TANK SECTION**  
SCALE: 1/8" = 1'-0" (11x17 SHEET)  
1/4" = 1'-0" (24x36 SHEET)

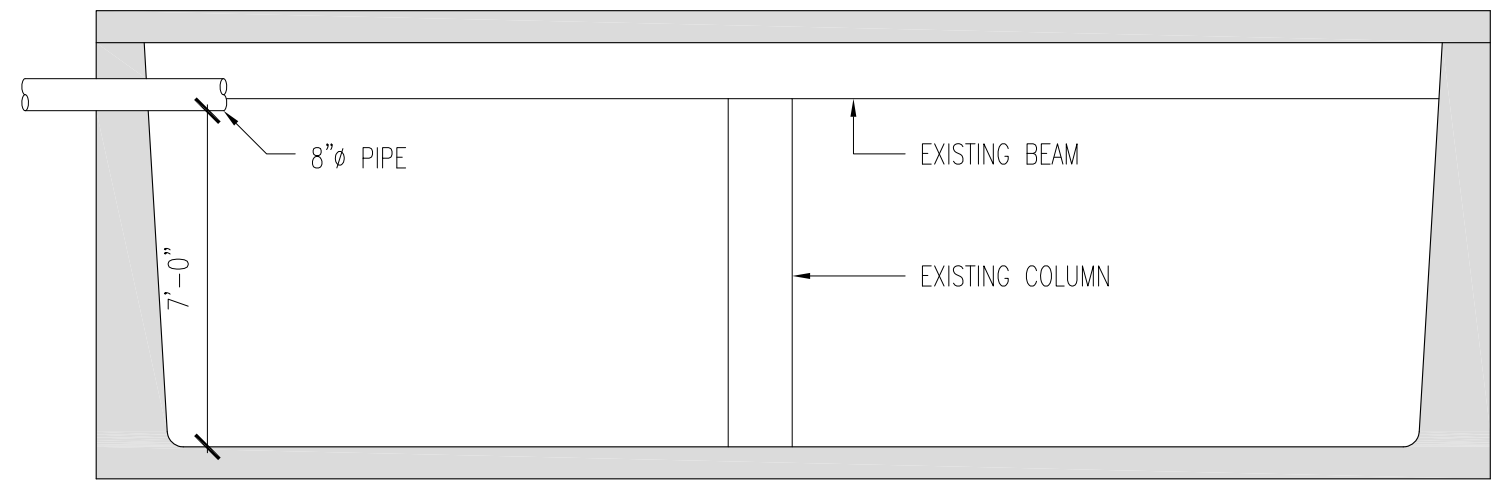

**2 PROPOSED TANK SECTION**  
SCALE: 1/8" = 1'-0" (11x17 SHEET)  
1/4" = 1'-0" (24x36 SHEET)

Xxx, 2019	-	ISSUED FOR
DATE	NO:	REVISION
 <small>t: 441.297.6191 • info@brunel.bm • www.brunel.bm</small>		
<b>PROJECT:</b> MARINE & PORTS EAST BROADWAY INTEGRATED PROJECTS		
<b>TITLE:</b> PROPOSED TANK SECTIONS		
SCALE:	AS SHOWN	JOB NO: 20-031
DRAWN BY:	JC	DRAWING #:
DATE:	JUNE 2020	<b>S1.3</b>
<small>DRAWING SCALE SHOWN IS FOR FULL-SIZE DRAWINGS. DRAWINGS PLOTTED ON 11"x17" SHEETS ARE HALF SCALE SHOWN (1/4"=1'-0" ON 24"x36" SHEET = 1/8"=1'-0" ON 11"x17" SHEET)</small>		




FUEL & DIESEL DISTRIBUTION LEGEND	
	EXISTING BUILDINGS
	ASPHALT SURFACE
	GRASS / VEGETATION SURFACE
	FLOATING DOCK
	OCEAN
	EXISTING FUEL PIPING
	EXISTING DIESEL PIPING
	PROPOSED FUEL PIPING
	PROPOSED DIESEL PIPING
	ABANDONED DISTRIBUTION PIPING

1 PROPOSED FUEL & DIESEL - OPTION 2  
 SCALE: 3/32" = 1'-0" (11x17 SHEET)  
 3/4" = 1'-0" (24x36 SHEET)

JUNE 2020	-	ISSUED TO CLIENT
DATE	NO:	REVISION
 t: 441.297.6191 • info@brunel.bm • www.brunel.bm		
PROJECT:		
MARINE & PORTS EAST BROADWAY INTEGRATED PROJECTS		
TITLE:		
PROPOSED FUEL & DIESEL DESIGN LAYOUT - OPTION 2		
SCALE:	AS SHOWN	JOB NO: 20-031
DRAWN BY:	JC	DRAWING #:
DATE:	JUNE 2020	<b>S1.4</b>
DRAWING SCALE SHOWN IS FOR FULL-SIZE DRAWINGS. DRAWINGS PLOTTED ON 11"x17" SHEETS ARE HALF SCALE SHOWN (1/4"=1'-0" ON 24"x36" SHEET = 1/8"=1'-0" ON 11"x17" SHEET)		



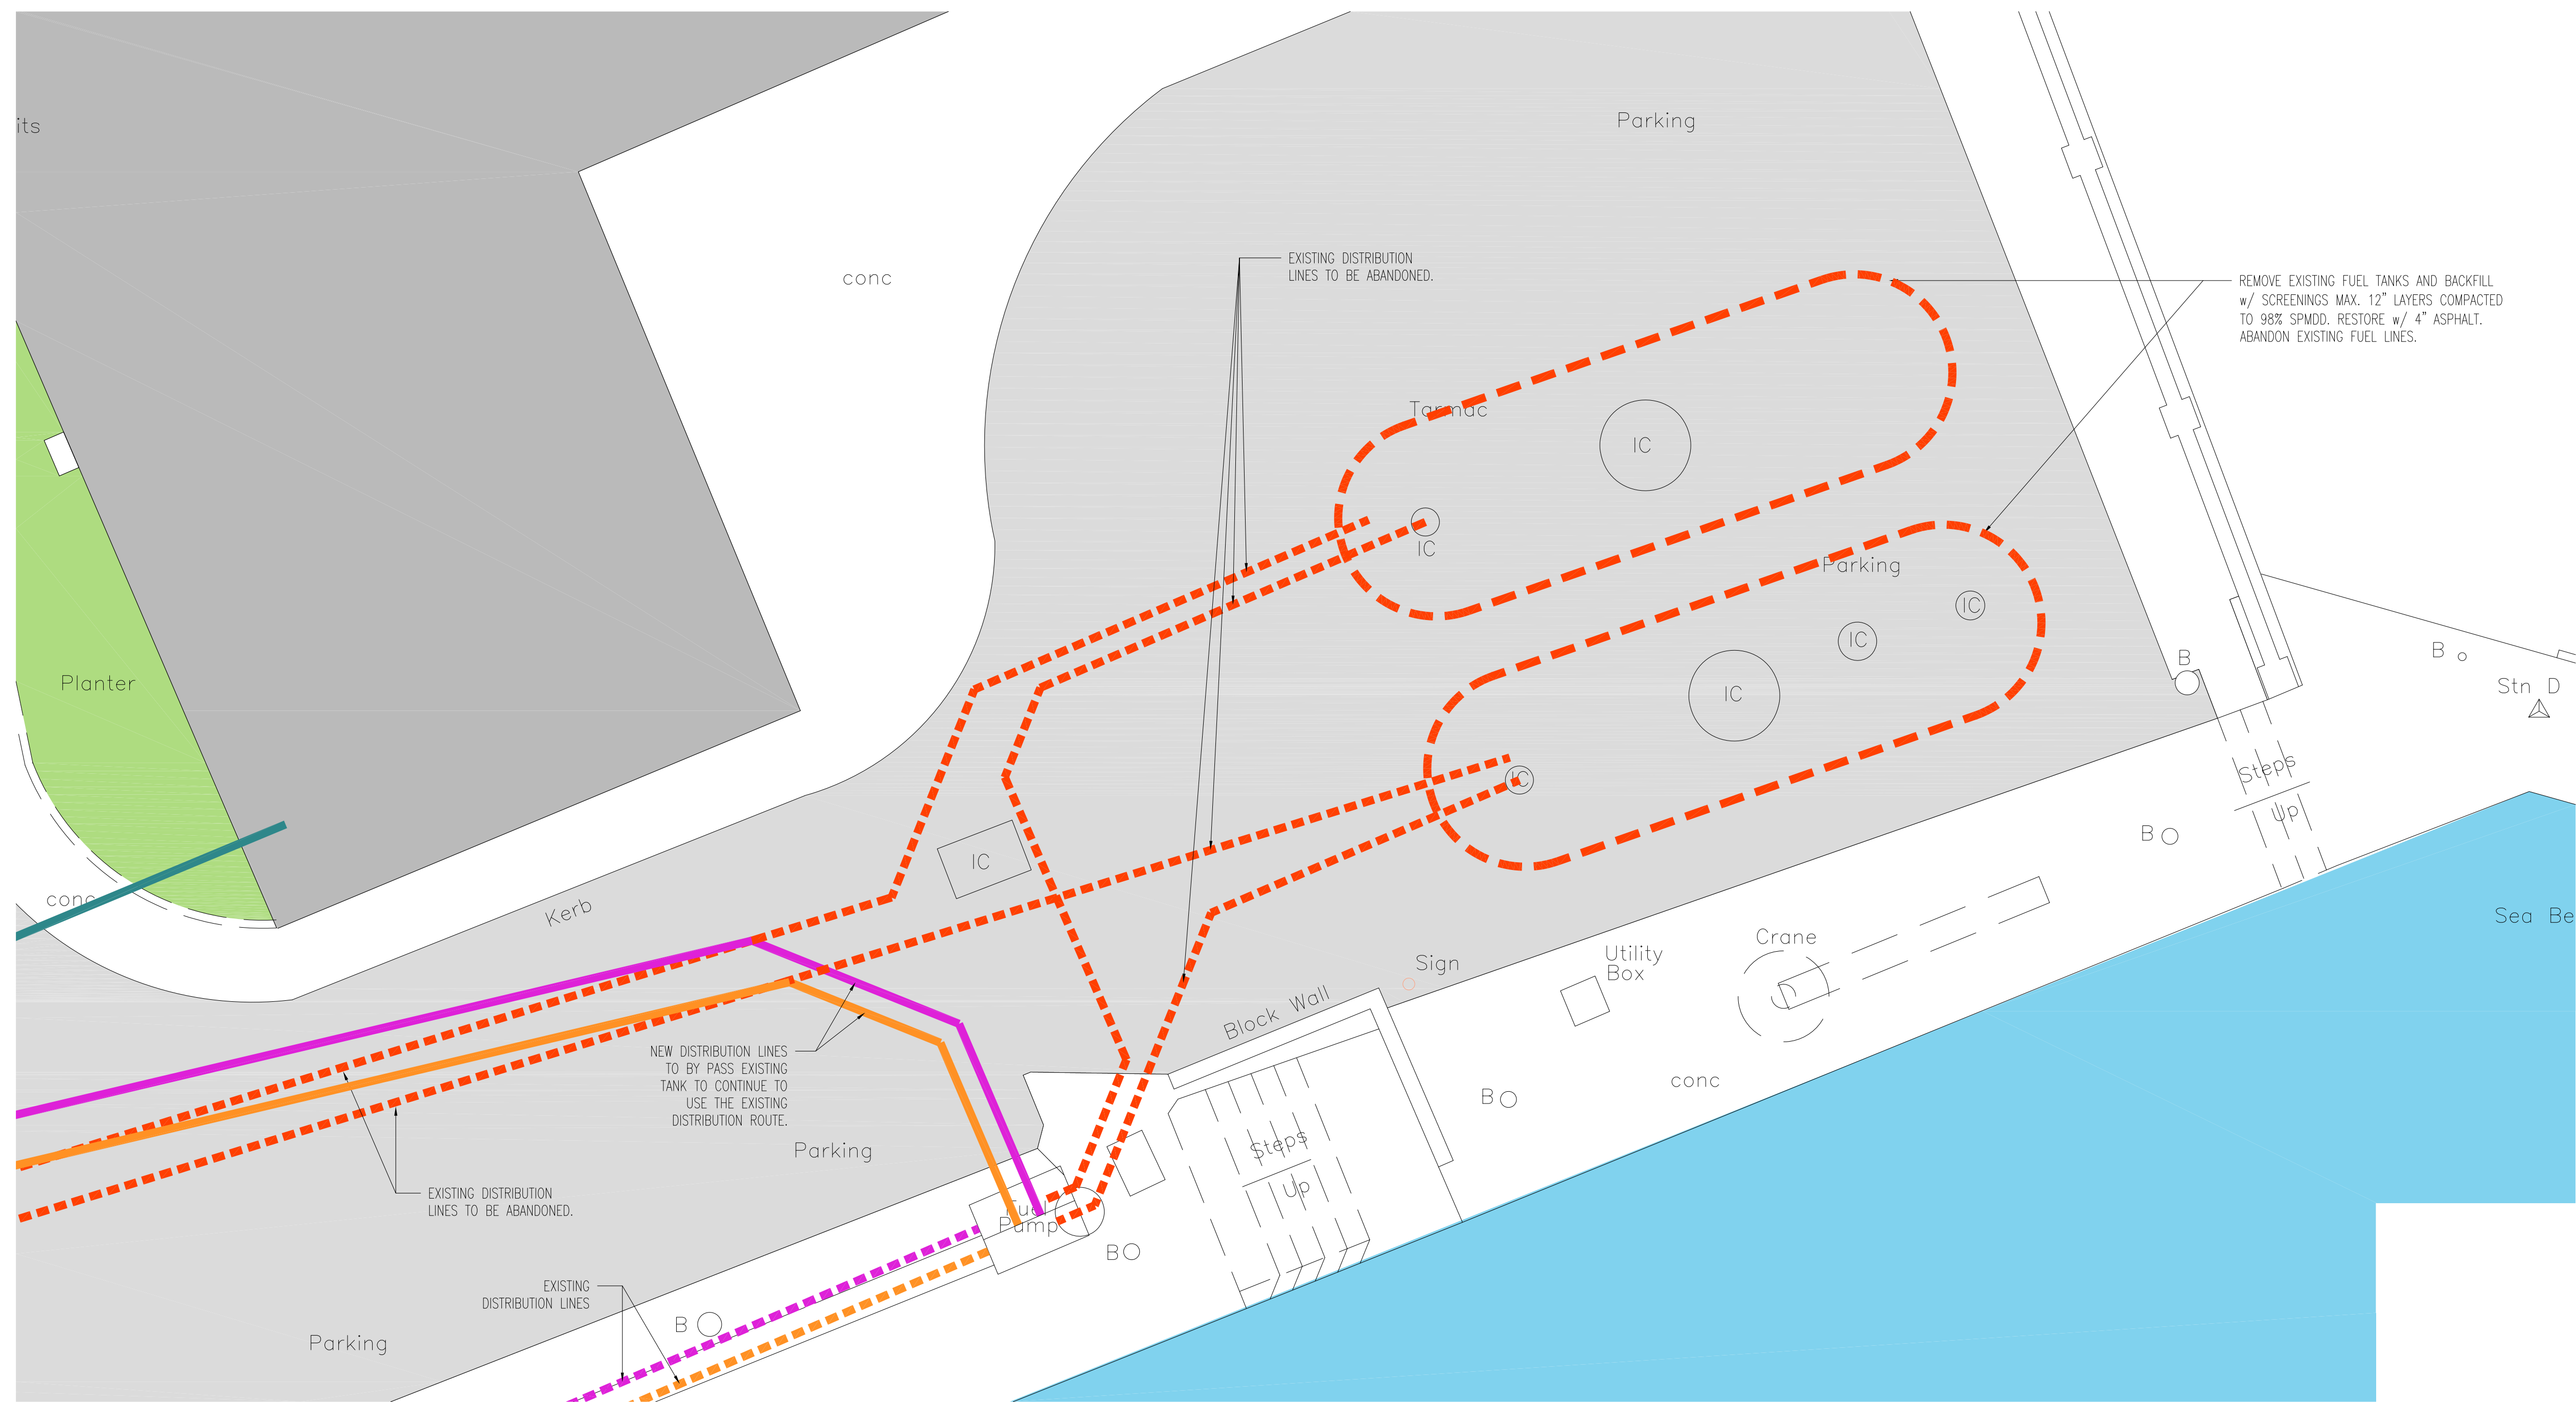

FUEL & DIESEL DISTRIBUTION LEGEND	
	EXISTING BUILDINGS
	ASPHALT SURFACE
	GRASS / VEGETATION SURFACE
	FLOATING DOCK
	OCEAN
	EXISTING FUEL PIPING
	EXISTING DIESEL PIPING
	PROPOSED FUEL PIPING
	PROPOSED DIESEL PIPING
	ABANDONED DISTRIBUTION PIPING

1 PROPOSED FUEL & DIESEL - OPTION 2  
 SCALE: 3/32" = 1'-0" (11x17 SHEET)  
 3/64" = 1'-0" (24x36 SHEET)

JUNE 2020	-	ISSUED TO CLIENT
DATE	NO:	REVISION
<b>BRUNEL</b> ENGINEERING CONSULTANTS		
t: 441.297.6191 • info@brunel.bm • www.brunel.bm		
PROJECT: MARINE & PORTS EAST BROADWAY INTEGRATED PROJECTS		
TITLE: PROPOSED FUEL & DIESEL DESIGN LAYOUT - OPTION 2		
SCALE:	AS SHOWN	JOB NO: 20-031
DRAWN BY:	JC	DRAWING #:
DATE:	JUNE 2020	<b>S1.5</b>
DRAWING SCALE SHOWN IS FOR FULL-SIZE DRAWINGS. DRAWINGS PLOTTED ON 11"x17" SHEETS ARE HALF SCALE SHOWN (1/4"=1'-0" ON 24"x36" SHEET = 1/8"=1'-0" ON 11"x17" SHEET)		





WATER DISTRIBUTION LEGEND	
	EXISTING BUILDINGS
	ASPHALT SURFACE
	GRASS / VEGETATION SURFACE
	FLOATING DOCK
	OCEAN
	PROPOSED WATER SUPPLY PIPING
	PROPOSED RAIN WATER LEADER PIPING

1  
S2.1 PROPOSED FRESH WATER DISTRIBUTION - SITE PLAN  
SCALE: 3/32" = 1'-0" (11x17 SHEET)  
3/64" = 1'-0" (24x36 SHEET)

JUNE 2020	-	ISSUED TO CLIENT
DATE	NO:	REVISION
 t: 441.297.6191 • info@brunel.bm • www.brunel.bm		
PROJECT:		
MARINE & PORTS EAST BROADWAY INTEGRATED PROJECTS		
TITLE:		
PROPOSED FRESH WATER SUPPLY DESIGN LAYOUT		
SCALE:	AS SHOWN	JOB NO: 20-031
DRAWN BY:	JC	DRAWING #:
DATE:	JUNE 2020	<b>S2.1</b>
DRAWING SCALE SHOWN IS FOR FULL-SIZE DRAWINGS. DRAWINGS PLOTTED ON 11"x17" SHEETS ARE HALF SCALE SHOWN (1/4"=1'-0" ON 24"x36" SHEET = 1/8"=1'-0" ON 11"x17" SHEET)		